

### **GENERAL BUILDING INFORMATION**

**LOT AREA CALCULATIONS: SETBACKS:** 

LOT AREA: 2,083 SQFT. REQUIRED EXISTING LOT COVERAGE FRONT: 7.01 9'-9 1/2" (EXISTING NON-COMPLIANT): 1,678 SQFT.(80.64%) SIDE: 2'-9 1/4" & -2" REAR: -3 1/2"

**OPEN SPACE: REQUIRED:** 

FIRST LEVEL:

**TOTAL AREA:** 

SECOND LEVEL:

**EXISTING NON-COMPLIANT:** PROPOSED: 0 SQFT.

400 SQFT. 0 SQFT.

**AREA BREAKDOWN:** 

923 SQFT. 1,572 SQFT. 1,422 SQFT. 3,917 SQFT. **NON-CONFORMING CONDITIONS: BUILDING HEIGHT** 

GROUND/BEACH LEVEL:

OPEN SPACE LOT COVERAGE SIDE SETBACKS **REAR SETBACK EAVE SETBACK** FIREPLACE SETBACK

547 SQFT. GARAGE: **BALCONIES:** 116 SQFT.

**EXISTING SF** 

923 SF

1,572 SF

1,402 SF

3,897 SF

FINISH DESIGNATION

**EXISTING WALL** 

DIRECTION OF SLOPE TO DRAIN

**NEW WALL** 


**EXHAUST FAN** 

FIRE SPRINKLER

SMOKE DETECTOR

**NORTH ARROW** 

**JUSTIFICATION FOR LESS THAN 50% REMODEL** \*SEE A-2 FOR PROJECT EVALUATION FORM

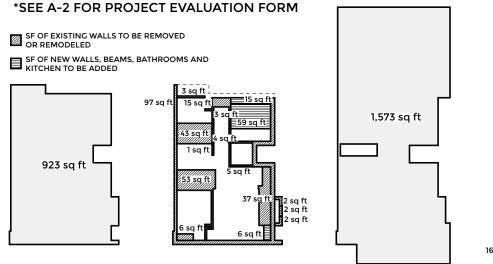

FIRST LEVEL **REMODELED SF** 

340 SF

549 SF

650 SF


1,539 SF

17.52.030 B ANY EXISTING NONCONFORMING PORTIONS OF THE STRUCTURE (E.G. A WALL NONCONFORMING TO A YARD

REQUIREMENT, OR A ROOF NONCONFORMING TO HEIGHT REQUIREMENTS) MAY BE PARTIALLY MODIFIED OR ALTERED ONLY TO THE

SHALL NOT BE COMPLETELY REMOVED AND REPLACED, AND IF COMPLETELY REMOVED MUST BE BROUGHT INTO COMPLIANCE WITH

EXTENT NECESSARY TO SATISFY THE UNIFORM BUILDING CODE AS RECOMMENDED BY A CERTIFIED STRUCTURAL ENGINEER BUT

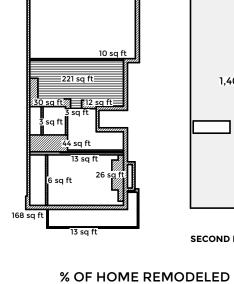



36.84%

34.92%

46.36%

39.49% < 50%

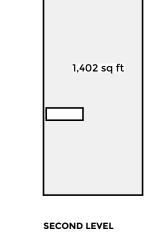

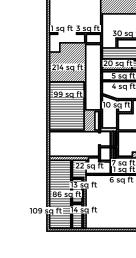

INTERIOR REMODEL OF (E) SINGLE FAMILY RESIDENCE, REPLACEMENT OF SIDING AND STONE VENEER, NEW GARAGE DOORS, RE-ROOFING, REPLACEMENT OF WINDOWS AND DOORS, REPLACEMENT OF BALCONY GUARDRAIL, REPAIR AND REPLACEMENT OF FASCIA BOARDS LIKE-FOR-LIKE. THERE SHALL BE NO PROPOSED CHANGES TO THE (E) BUILDING HEIGHT OR (E) ROOF STRUCTURE OR (E) NON-CONFORMING YARD WALLS. ANY (E) NON-CONFORMING PORTIONS OF THE STRUCTURE MAY BE PARTIALLY MODIFIED OR ALTERED ONLY TO THE EXTENT NECESSARY TO SATISFY THE UNIFORM BUILDING CODE AS RECOMMENDED BY A CERTIFIED STRUCTURAL ENGINEER BUT SHALL NOT BE COMPLETELY REMOVED AND REPLACED, AND IF COMPLETELY REMOVED MUST BE BROUGHT INTO COMPLIANCE WITH CURRENT REQUIREMENTS.

2013 CALIFORNIA BUILDING CODE, 2013 CALIFORNIA GREEN BUILDING STANDARDS CODE,

**PARKING:** (E) 3 CAR GARAGE

### **SYMBOLS**

LAMINATE **ABOVE FINISH FLOOR** LAVATORY ABOVE FINISH GRADE LT FXT AFG LIGHT FIXTURE **ACOUS** ACOUSTICAL MAX **MAXIMUM MECHANICAL** ADJ **ADJUSTABLE** MECH **ALUMINUM** METAL ANCHOR MIN MINIMUM **APPROX APPROXIMATELY NOT IN CONTRACT ATTENUATION** OC BOARD ON CENTER **BLDG** OD **OUTSIDE DIAMETER** BUILDING BLK **BLOCK** P.C. PROPERTY CORNER BEAM P.L. PROPERTY LINE B.O. **BOTTOM OF** PLATE COMPACT PARKING STALL (C) PLASTER **CLEAR ANODIZED PLWD** PLYWOOD CAB CABINET RISERS CER CERAMIC RD **ROOF DRAIN** CJ **CONTROL JOINT** R.O. **ROUGH OPENING** RAD **RADIUS** CL CLOSET C.L. **CENTER LINE** RDL **ROOF DRAIN LEADER** CLG CEILING REC RECESSED CLR CLEAR REINF REINFORCED CMU **CONCRETE MASONRY UNIT** REQ'D REQUIRED COL COLUMN RES **RESISTANT** CONC CONCRETE RESIL RESILIENT CONST CONSTRUCTION RET **RETAINING** CONT CONTINUOUS REV. REVERSE DBL DOUBLE ROOM DTL S.S. DETAIL STAINLESS STEEL DIA DIAMETER SHEET VINYL **SCHED** DIAG DIAGONAL SCHEDULE DIM **DIMENSION** SECT SECTION SAU DN DOWN SFR DS DOWNSPOUT SINGLE FAMILY RESIDENCE SHT DWG DRAWING SHEET SIM EA EACH SIMILAR **SPEC ELEVATION SPECIFICATION ELECT ELECTRICAL** SQ SQUARE STANDARD EQ **EQUAL** STD **EQUIPMENT** STL **EQUIP** STEEL STRUCT STRUCTURAL **EXISTING EXTERIOR** SUSP SUSPENDED EXT **FLOOR DRAIN** TREADS FD T&B TOP AND BOTTOM FIN. FINISH FINISH FLOOR ELEVATION F.F.E. T&G **TONGUE AND GROOVE** T.O. FLR **FLOOR** TOP OF **FLUORESCENT** T.O.C. **FLUOR TOP OF CONCRETE FACE OF** F.O. TOPPING FOOT TELE TELEPHONE TEMPERED FTG FOOTING **TEMP** 

T.S.

TYP

VCT

**ABBREVIATIONS** 

FIELD VERIFY

GALVANIZED

HARDWOOD

HORIZONTAL

**INSULATION** INTERIOR

**GALVANIZED IRON** 

**GYPSUM BOARD** 

**INSIDE DIAMETER** 

GAUGE

GLASS

HEIGHT

GI **GALV** 

GL

GYP BD

**HDWD** 

HORIZ

INSUL

SOLID LINE DASHED LINES INDICATE HIDDEN. **BUILDING FLOOR OR ELEVATION** — — - - — PROPERTY LINE **BREAK LINE - MATERIAL TO CONTINUE** GRIDLINE ON CENTER OF COLUMN **GRIDLINE TO FACE OF STRUCTURE DIMENSION TO CENTERLINE DIMENSION TO FACE BUILDING SECTION** WALL SECTION

101

SELF ADHERING UNDERLAYMENT

TUBE STEEL

WATER CLOSET

WIDE FLANGE

**WATERPROOF** 

**PLUS OR MINUS** NUMBER

WOOD

**UNLESS NOTED OTHERWISE** 

**UNREINFORCED MASONRY** 

WEATHER RESISTANT BARRIER

VINYL COMPOSITION TILE

TYPICAL

BEACH LEVEL


**BEACH LEVEL** 

**FIRST LEVEL** 


**TOTAL** 


**SECOND LEVEL** 


CURRENT REQUIREMENTS.

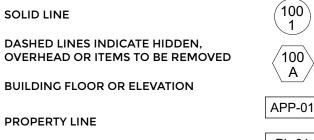




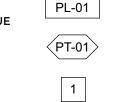


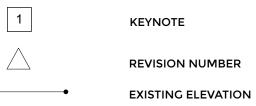


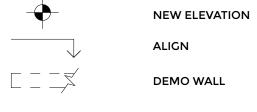

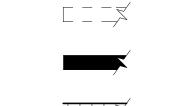





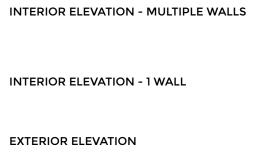


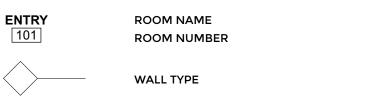



**MATERIALS** 

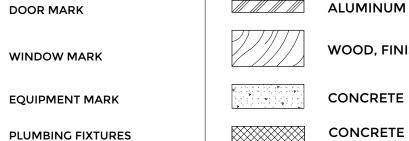


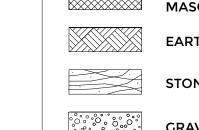

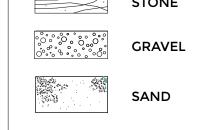


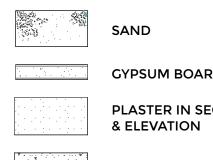

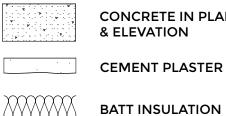

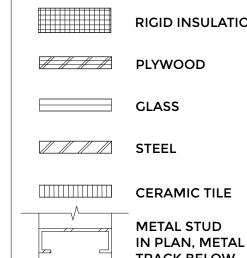


WOOD, FINISH CONCRETE CONCRETE **MASONRY UNIT** EARTH **STONE** 

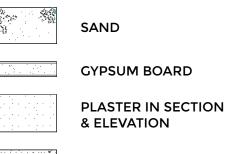





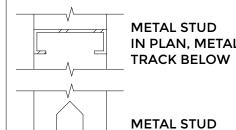

IN ELEVATION

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### PROJECT DIRECTORY

**PROJECT INFORMATION** 

LOT 11 / BLOCK 1 / CITY:REGION/CLUSTER: 14/14161 \ TRACT NO. 6210.02

PROJECT ADDRESS 3330 THE STRAND

**LEGAL DISCRIPTION:** 

APN#:

ZONE:

HBR1

2,083 SF

(E) LIVING: 3,181 SF

(N) LIVING: 0 SF

1,466 SF

STORIES: **3 STORIES** 

R3/U

**REMODELED SF:** 

**BUILDING CODES:** 

**OCCUPANCY GROUP:** 

CONSTRUCTION TYPE:

**FIRE SPRINKLERS:** 

2013 CMC, 2013 CEC, 2013 CPC, 2013 CRC

4181-034-009

SITE AREA (NET):

HERMOSA BEACH, CA 90254


**PROJECT OWNER** JEFF DAVID 3330 HERMOSA AVE HERMOSA BEACH, CA 90254 (310) 874-5333 JDAVID@KINGS.COM


**ARCHITECT** ANTHONY LANEY, AIA LANEY LA INC 15420 ATKINSON AVE GARDENA, CA 90249 ANTHONY@LANEY.LA (310) 498-2455

STRUCTURAL ENGINEER BEYOND ENGINEERING INC. 18199 S. PRAIRIE AVE, SUITE 102, TORRANCE, CA 90504 (310) 793-8410 **GENERAL CONTRACTOR** 

TITAN AND CO., INC. 1601 N SEPULVEDA BLVD #622 MANHATTAN BEACH, CALIFORNIA 90266 (310) 773-3880

### **VICINITY MAP**

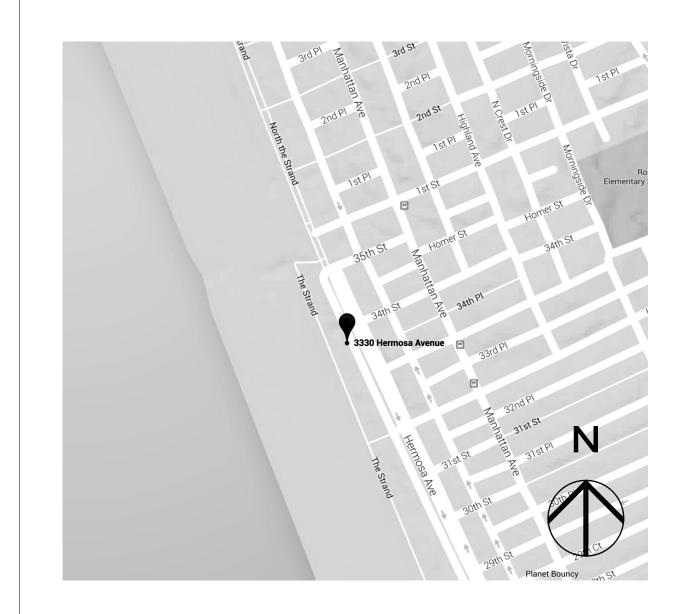

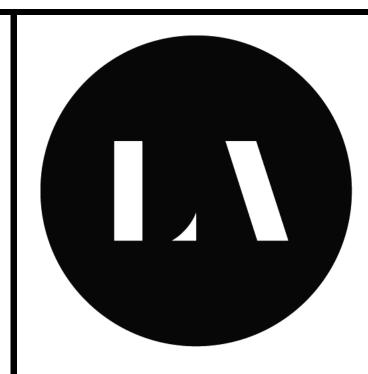

LANEY LA

LIFESTYLE + ARCHITECTURE

**PROJECT NAME** 

THE STRAND PALACE

**PROJECT NUMBER** 

CLIENT **JEFF DAVID** 

PROJECT ADDRESS 3330 THE STRAND

HERMOSA BEACH, CA 90254

**ARCHITECT** ANTHONY LANEY AIA LANEY LA INC **15420 ATKINSON AVE** GARDENA CA 90249 (310) 498-2455

ANTHONY@LANEY.LA




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CHK D B1:	
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SHEET TITLE

**COVER SHEET** 



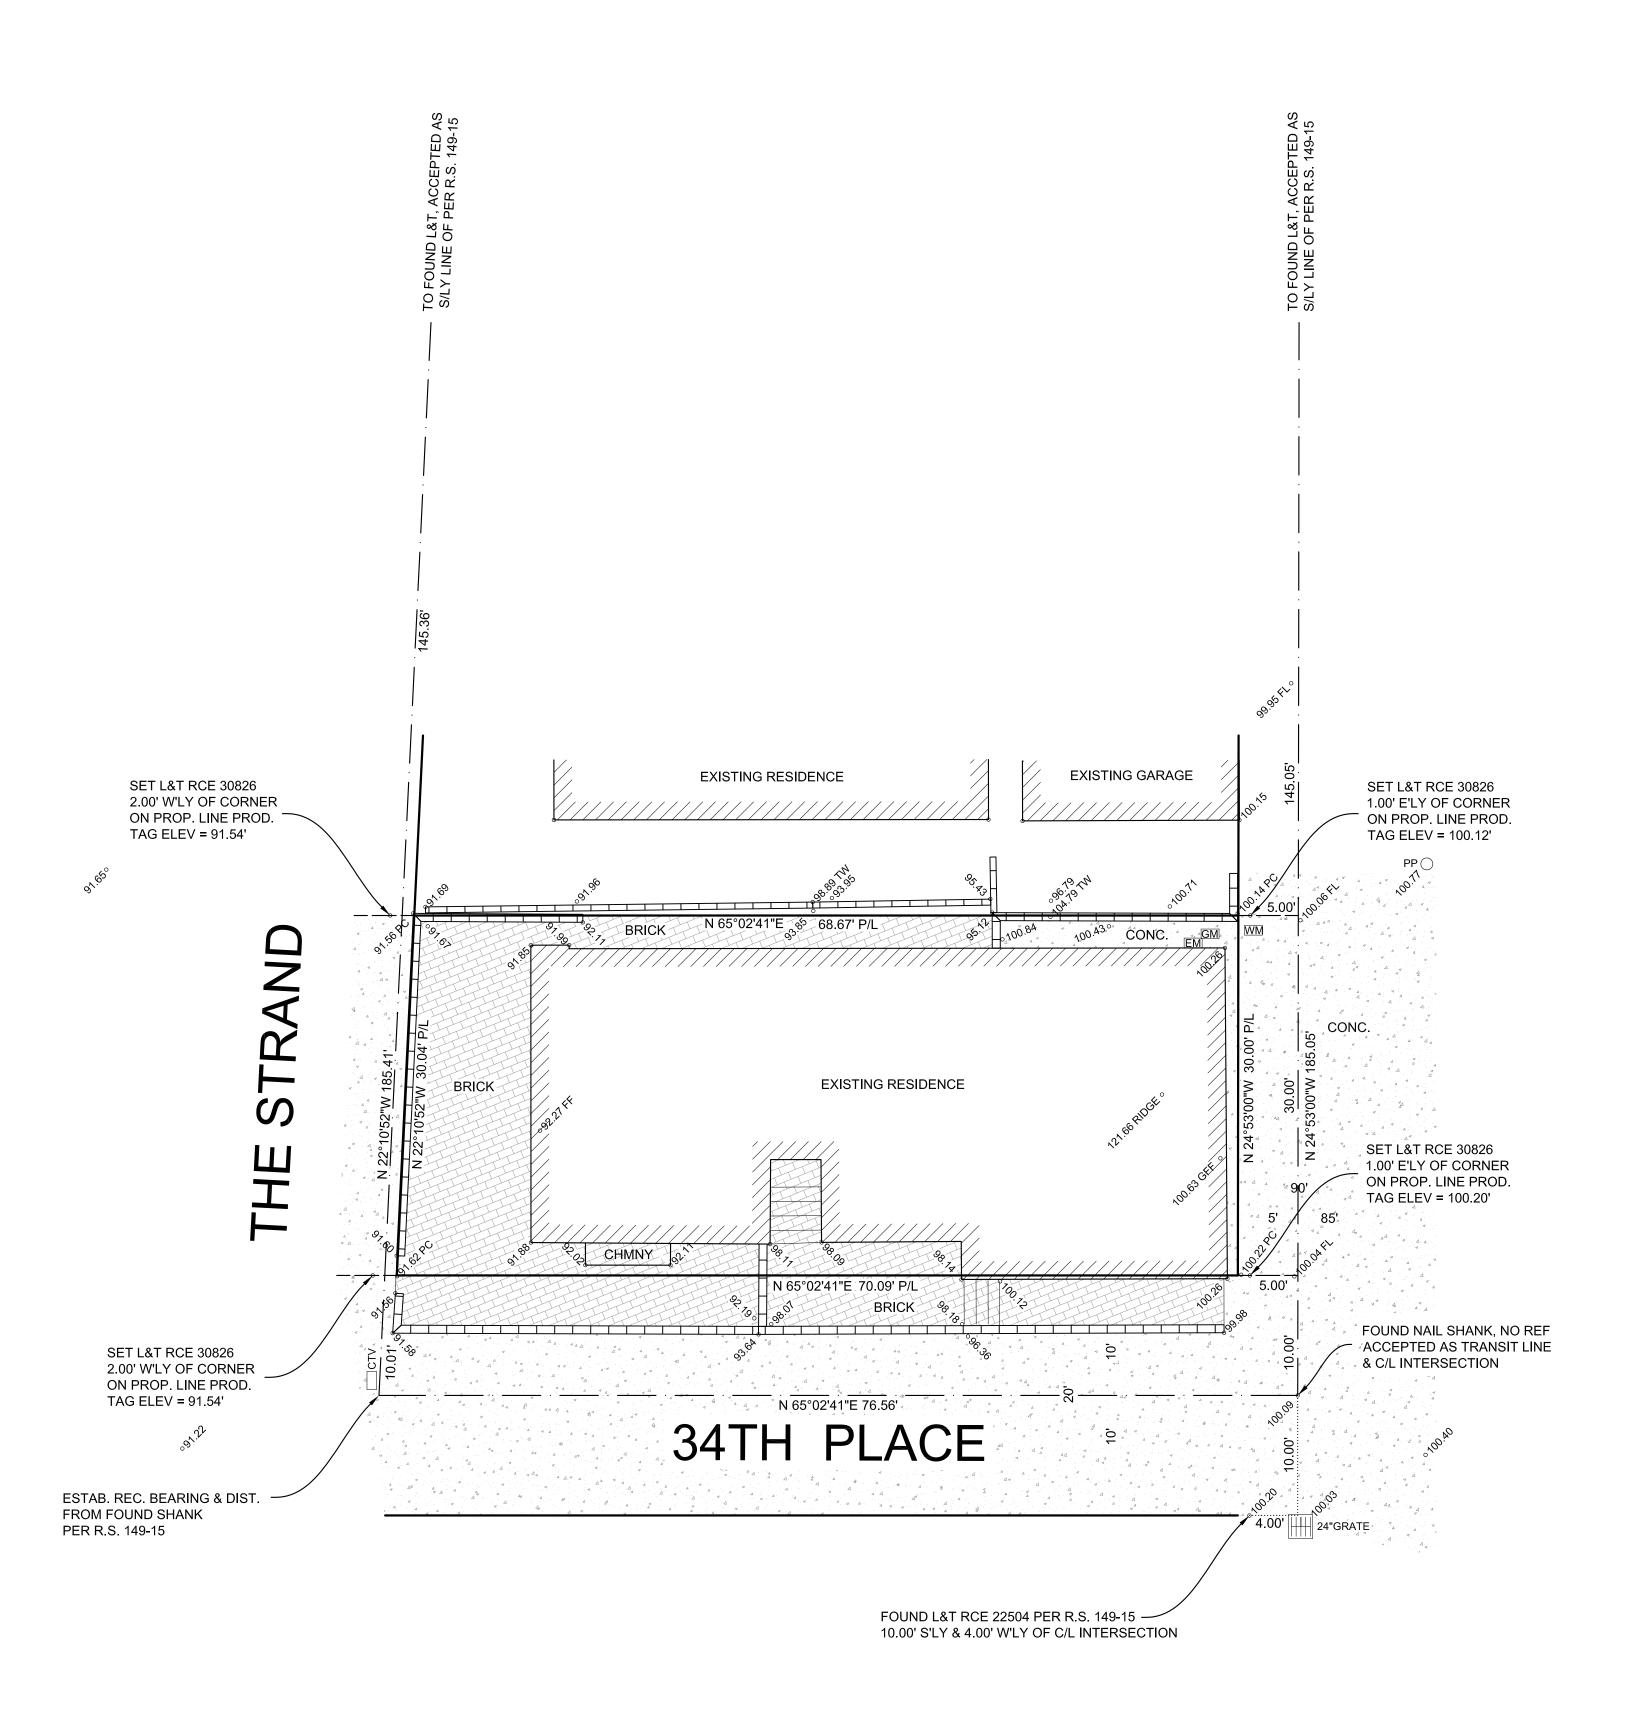

3914 DEL AMO BLVD, SUITE 921 TORRANCE, CA 90503 (310) 542-9433

### **SURVEY AND TOPOGRAPHY**

FOR JEFF DAVID

3330 THE STRAND

HERMOSA BEACH, CA 90254 PHONE 916-928-5190

JOB ADDRESS 3330 THE STRAND

HERMOSA BEACH, CA 90254

LEGAL DESCRIPTION

LOT 11, BLOCK 1 SHAKESPEARE BEACH M.B. 4-83-84 APN 4181-034-009

THIS MAP CORRECTLY REPRESENTS A SURVEY MADE BY ME OR UNDER MY DIRECTION IN CONFORMANCE WITH THE REQUIREMENTS OF PROFESSIONAL LAND SURVEYORS' ACT

GARY J. ROEHL R.C.E. 30826

CHECK BY TS/MW

DRAWN ON

REVISIONS

### **LEGEND**

BRICK BUILDING

CONCRETE

∘ 106.76 EXISTING ELEVATION 100 ✓ EXISTING CONTOUR

CHAIN-LINK

BLOCK WALL — X — EXISTING FENCE BEGINNING OF CURB RETURN CENTERLINE

C/L C.L.F. E'LY **EASTERLY** ELECTRIC METER EM FOUND FENCE

FINISH FLOOR FIRE HYDRANT FLOW LINE

GARAGE FINISH FLOOR GFF GAS METER **GUY WIRE** 

LEAD AND TAG MANHOLE NORTHERLY

PROPERTY CORNER / PROP. CORNER PROPERTY LINE / PROP. LINE POWER POLE PARAPET

SPIKE AND WASHER S'LY SOUTHERLY

SPK SANITARY SEWER CLEAN OUT

SSMH SANITARY SEWER MANHOLE STAKE STK

STREET LIGHT TOP OF CURB

TOP OF WALL / T.O.W. TOP OF DRIVEWAY APRON

W'LY WESTERLY WM WATER METER

NOTE: ALL SETBACK DIMENSIONS SHOWN ARE MEASURED TO EXTERIOR SURFACE OF BUILDINGS UNLESS OTHERWISE NOTED.

BOUNDARY MONUMENTS ARE NOT NECESSARILY SET ON PROPERTY CORNERS. PLEASE REFER TO THE NOTATION ON THE PLANS FOR OFFSET DISTANCES. IF THERE ARE ANY QUESTIONS, PLEASE DO NOT HESITATE TO CONTACT DENN ENGINEERS FOR CLARIFICATION AT:

COPYRIGHT ANY CHANGES OR MODIFICATIONS MADE TO THIS PLAN WITHOUT WRITTEN CONSENT OF DENN ENGINEERS SHALL RELIEVE DENN ENGINEERS FROM ANY LIABILITY OR DAMAGE RESULTING FROM SUCH CHANGES OR

(310) 542-9433, M-F 8:00 AM TO 5:00 PM.

SHEET 1 OF 1


MODIFICATIONS, INCLUDING ANY ATTORNEYS FEES OR

JOB NO. 16-321

COSTS INCURRED IN ANY PROCEEDING THAT DENN

ENGINEERS MAY BE JOINED.

A TITLE POLICY WAS NOT PROVIDED TO DENN ENGINEERS AT THE TIME OF THIS SURVEY. THEREFORE, DENN ENGINEERS DOES NOT GUARANTEE THE LEGAL DESCRIPTION OF THIS PROPERTY SURVEYED NOR DOES IT REFLECT OR DELINEATE ANY EASEMENTS THAT MAY BE ON SAID PROPERTY.

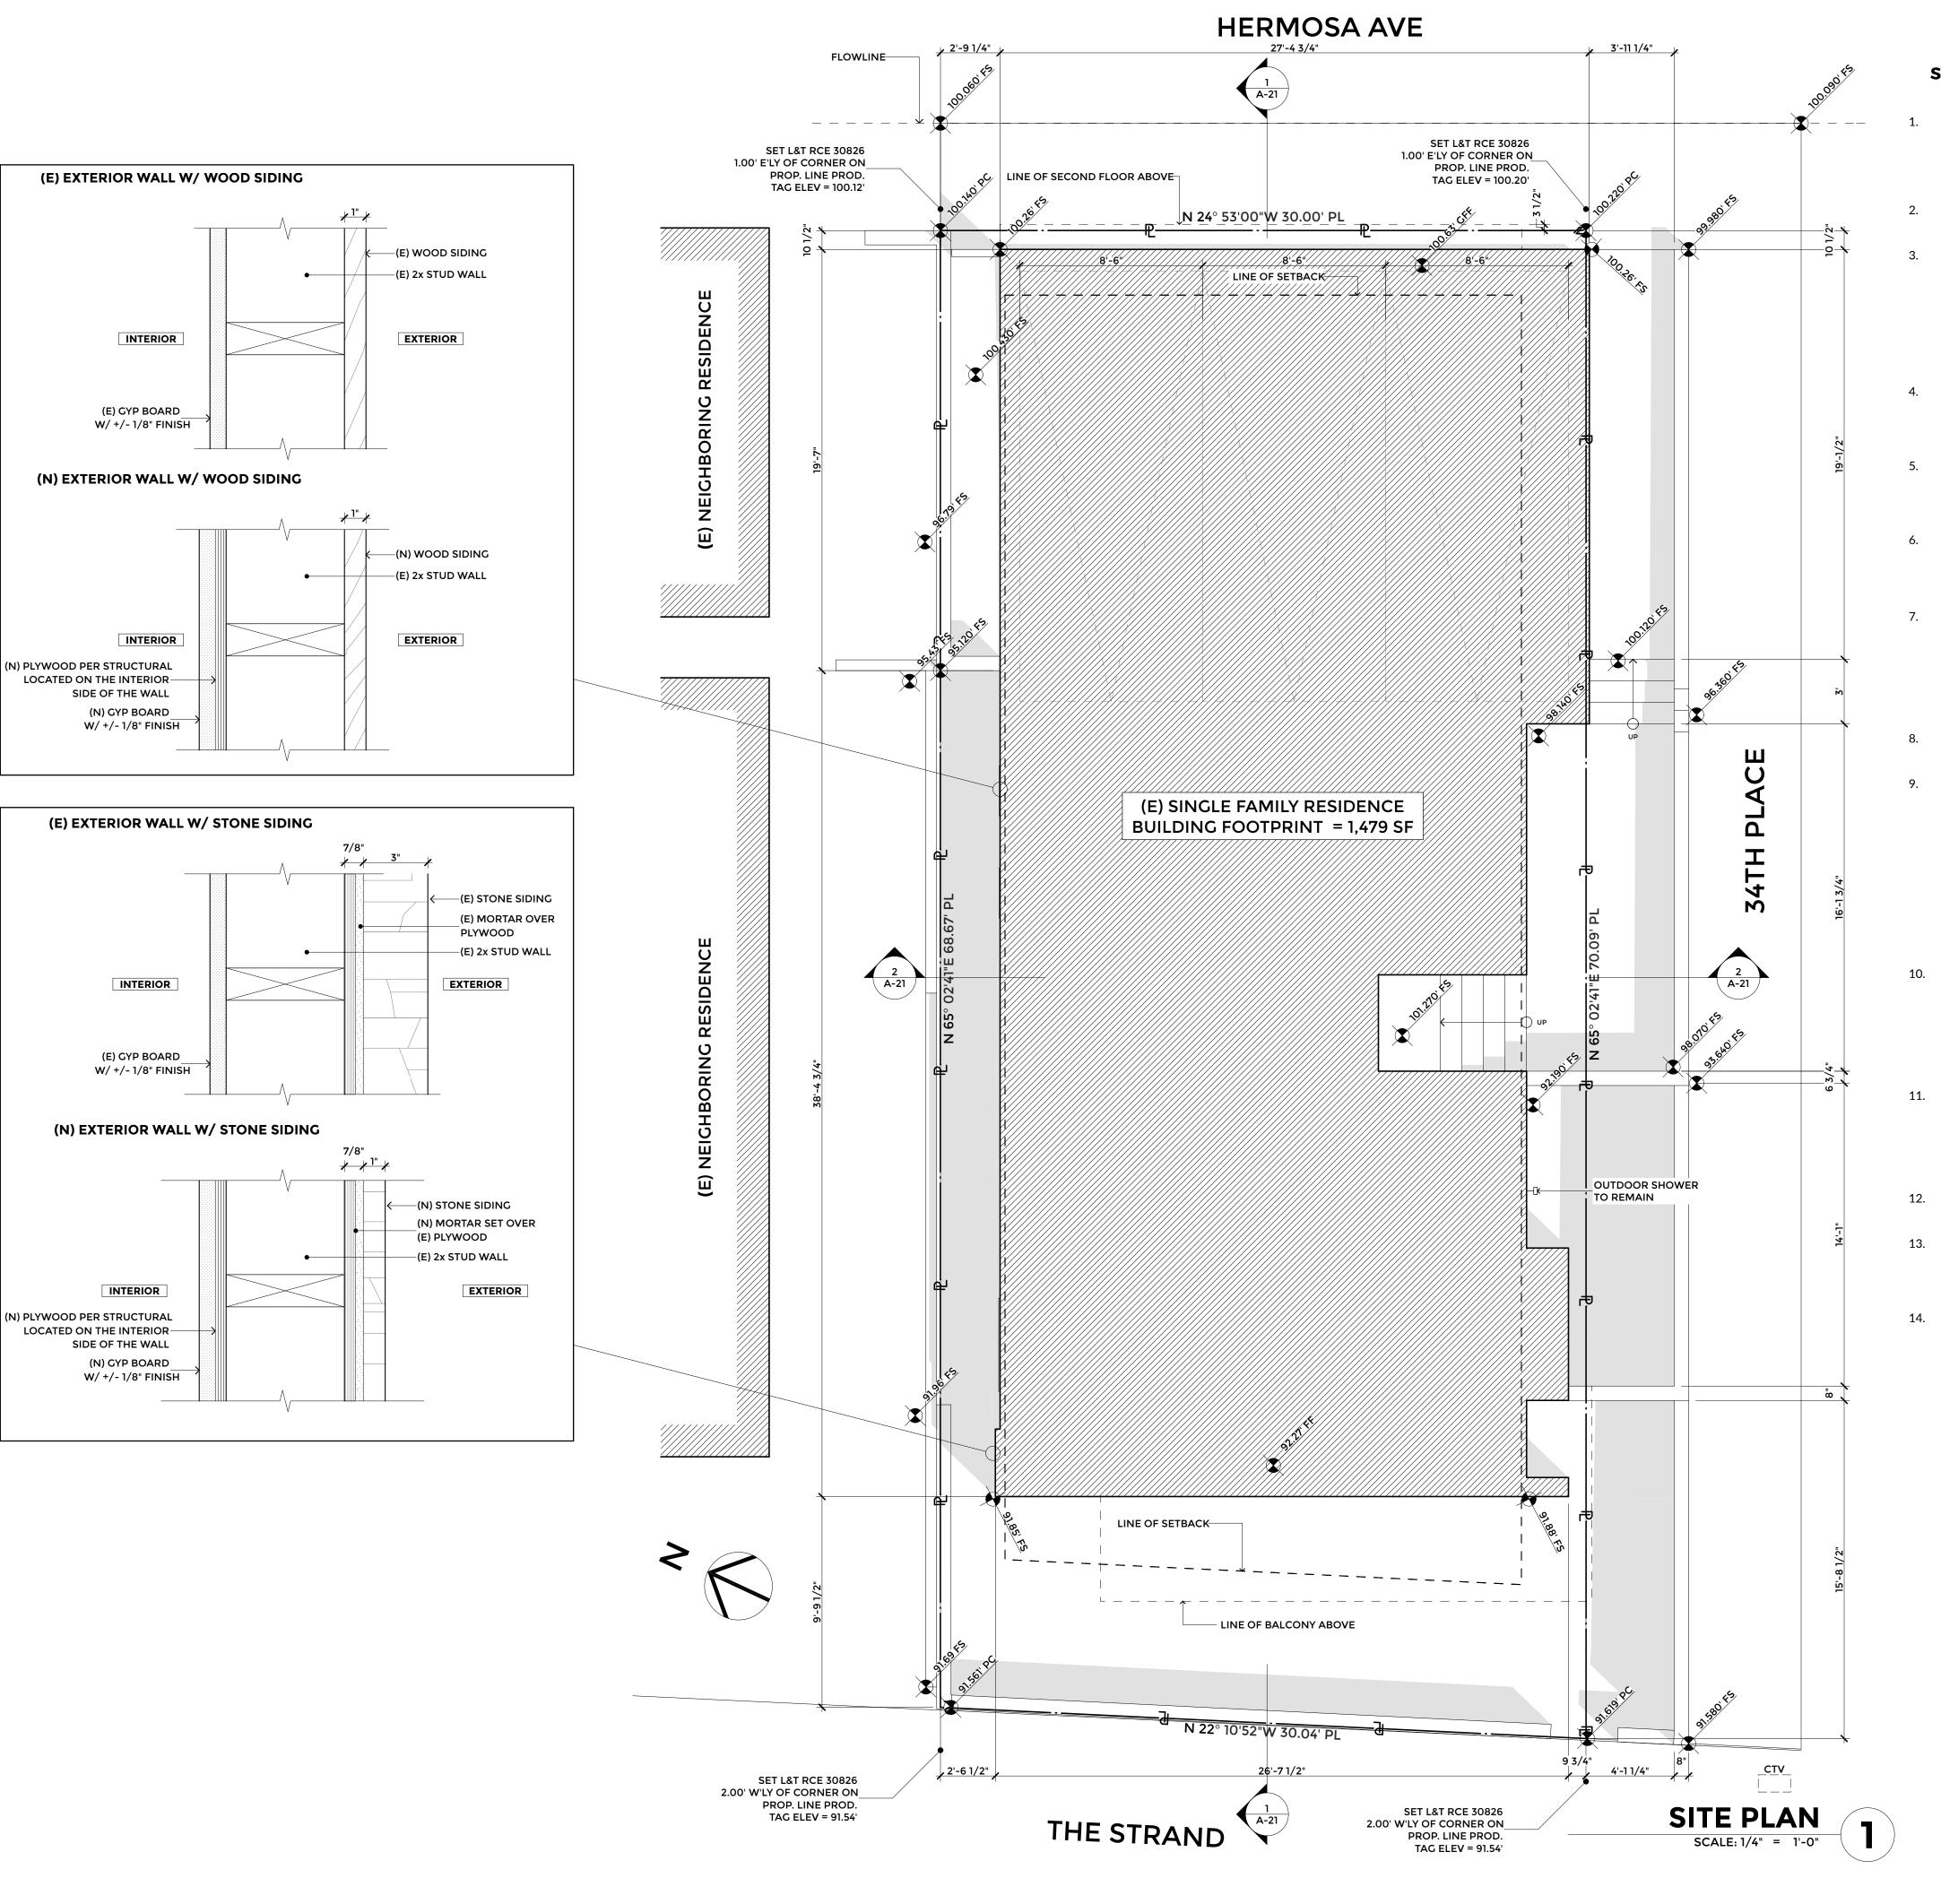

### SITE PLAN NOTES

- Conditions deviating from drawings or reports. If, during the course of excavation, shoring, backfill or compaction, if any conditions are uncovered which deviate from what is shown on the drawings or reports (if any) that is other than anticipated in normal construction experience, immediately notify the architect.
- 2. Setbacks. Verify that all code required setbacks and height limitations are observed.
- Protection of persons and property.
- A. Barricade open depressions and holes occurring as part of this work.
- B. Protect all adjacent structures, utilities, sidewalks, pavements, and other facilities from damage caused by settlement, lateral movement, undermining, washout, and other hazards created by operations under this section.
- Protection of existing planting and trees. All existing plant material and trees not indicated to be removed shall be protected to the drip-line during demolition and construction. Any planting or trees that are damaged or killed shall be replaced at no cost to the owner.
- Protection of existing structures. All existing structures not indicated to be removed shall be protected during demolition and construction. Any finishes that are removed or otherwise damaged shall be replaced at no cost to the owner.
- 6. Construction fence.
  - A. Provide a construction fence to prevent unauthorized entry onto the construction site and protection of structure and materials.
- 7. Utilities.
  - A. Coordinate location of all new utility connection points and meters with architect prior to performing any work.
  - B. Protect all existing utility supplies, connection points and meters from damage.
- 8. Sewer cleanouts. Coordinate location of all sewer cleanouts w/ architect prior to performing any work.
- 9. Exterior paving. (See item 11 below for additional criteria)
  - A. All exterior paving shall be sloped to drain to either area drains, the street or to adjacent planting areas, depending on the location and condition.
  - B. Verify finishes of paving joints for all exterior paving prior to performing any work.
  - C. Verify quantity and locations of control joints for all exterior paving prior to performing any work.
- 10. Storm drainage / susmp requirements.
  - A. Verify with governing agencies if a storm water urban mitigation plan (susmp) or other pollution prevention filtering system is required.
  - B. All downspouts and area drains shall connect into pvc drainage pipes that terminate at the susmp or to the street as required.
- 11. Patios and porches at outswinging doors. Verify that height of the finish surface will comply with the code required maximum allowable height difference of 1" between the top of the threshold and the top of the exterior finish surface. Coordinate with threshold detail and finish surface material installation procedure. Notify architect before proceeding with any work if the condition does not comply with code.
- 12. Yard walls. Verify that all new yard walls comply with zoning code height
- 13. Curb cuts and sidewalks. Contractor is required to obtain a separate permit for all curb cuts and sidewalk construction. Construct all new curb cuts and sidewalks per approved city engineering or public works department requirements.
- 14. Landscape coordination. Provide and coordinate all required water supply's and power outlets required for landscape irrigation system.



LANEY LA

LIFESTYLE + ARCHITECTURE

PROJECT NAME
THE STRAND PALACE

PROJECT NUMBER 16087

CLIENT

JEFF DAVID

PROJECT ADDRESS
3330 THE STRAND
HERMOSA BEACH, CA 90254

ARCHITECT
ANTHONY LANEY AIA
LANEY LA INC
15420 ATKINSON AVE
GARDENA CA 90249
(310) 498-2455
ANTHONY@LANEY.LA



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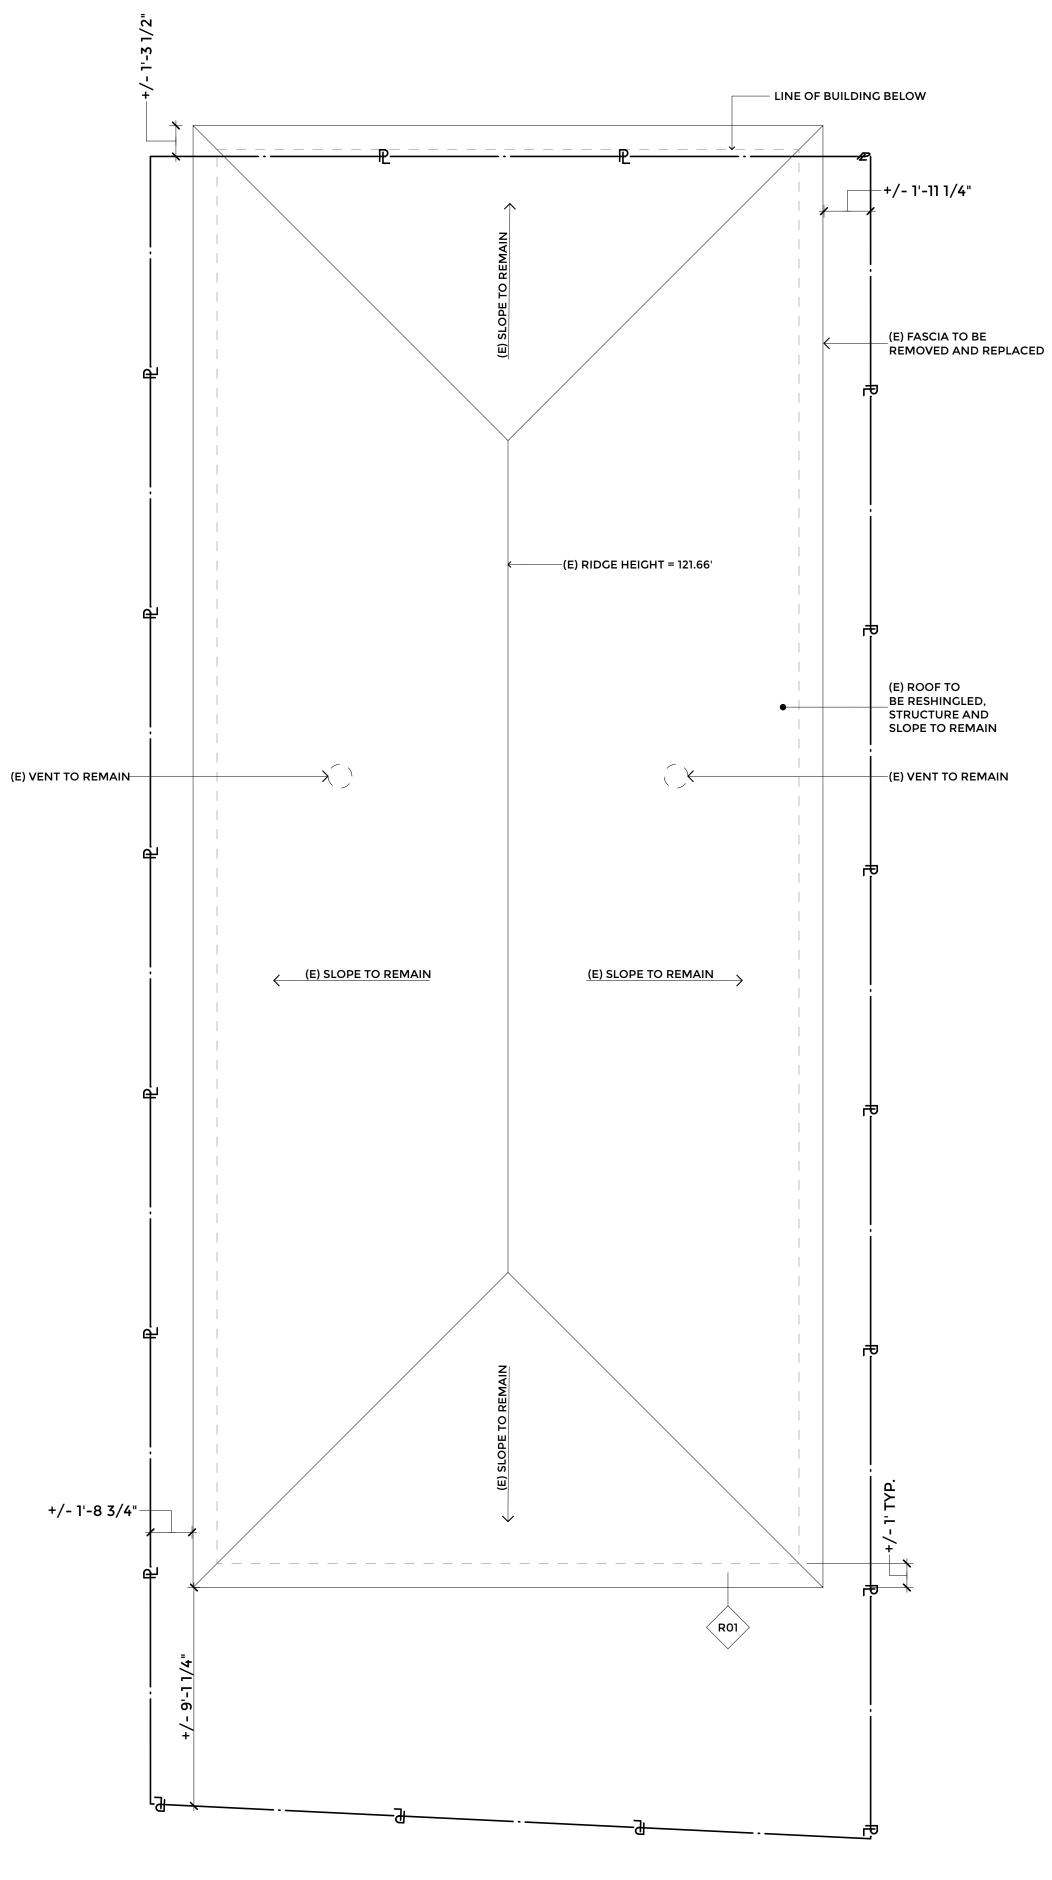
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SHEET TITLE

SITE PLAN





### 18. MATERIAL SAFETY DATA SHEETS: Roofing Sub-Contractor shall possess and

- maintain a copy of the manufacturer's specifications, MSDS (Material Safety Data Sheets), related documents, Architects Specifications and drawings and any addendum information at all times during the installation of the roofing systems.
- 19. GUARANTEE / WARRANTY: Provide a minimum Manufacturer and Applicator 15-year Sytstems Guarantee for all installed decks and roofs, unless a higher limit is required by the Owner, Consultant or by the Construction Specifications.
- 20. EMERGENCY REPAIRS: Roofing Sub-Contractor shall make all emergency repairs within 24 hours of notification by the Owner throughout the guarantee period.
- 21. THROUGH ROOF VENT PIPING: All vent pipes, etc., shall extend above the roof surface to allow for proper flashing and shall be painted a color to match or closely blend with the roof color unless otherwise noted.
- 22. FLASHING: The minimum gauge flashing allowed on the project shall be 24 GA Galvanized Iron, unless specified differently in the drawings or specifications. Follow the details and specifications of SMACNA's (Sheet Metal and Air Conditioning Contractors National Association) Architectural Sheet Metal Manual, its specifications and its standards. This is the minimum standard for this project. No aluminum flashing is allowed unless expressly permitted in writing. All roof penetrations shall be the responsibility of the Contractor to be painted to match surrounding roof surface.
- 23. DRAINAGE PATH: Where skylights, mechanical platforms or multiple platforms or skylights or any other impediment to the drainage of the roof to drains, the Contractor is responsible for providing a layout that resolves the impediments. Provide shop drawing showing proposed layout that adequately eliminates any and all impediments of the gravitational flow of water to drain. Crickets behind any of these items are a minimum requirement.
- 24. FLOOD TEST REQUIREMENTS: When approved by the Structural Engineer, Contractor to provide full flood test for a minimum of 24 hours. Utilize special inspections, shoring or other special methods if required to insure a safe and complete flood test.
- 25. CONTRACTORS RESPONSIBILITIES: Contractor shall be solely responsible for all roofing, decking and flashing installation failures for the warranty period. It is the contractors' responsibility to follow and / or resolve the installation failures with the subcontractor and / or product manufacturer at no cost or imposition to the Owner or Architect.
- 26. VALUE ENGINEERING: Any Value Engineering or relaxation of these requirements as noted herein, specified or otherwise detailed in the plans and specifications for roofing and / or deck waterproofing undertaken without written consent from the Architect, shall release the Architect from any and all liability for that portion of the project.
- 27. VENTS: See calculations for size and quantity.
- 28. COOL ROOF: Utilize cool roof for reduction of heat island effect.


### ROOF ASSEMBLY SCHEDULE

RO1

(N) ASPHALT SHINGLE ROOFING
(E) UNDERLAYMENT (V.I.F)
(E) 1X3 PURLINS/BOARDS (V.I.F.)
(E) 2X8 RAFTERS/TRUSSES (V.I.F.)

### STANDARD ROOFING NOTES

- APPEARANCE AND PERFORMANCE OF ROOF AND DECK: All roofing work shall result in a waterproof enclosure of good appearance, adequate drainage, puddles or standing water will not be permitted on any roof or deck and correction of such shall be at Contractors sole expense. The beginning of the work indicates acceptance of the base to which it is applied. The contractor shall advise the Architect if anything will interfere with the intention of this work.
- 2. MINIMUM STANDARDS FOR ROOFING AND DECK WATERPROOFING: Architectural and Engineering Drawings, Details and Construction Specifications shall govern over these notes when they are more restrictive or of a higher quality. Under no circumstance and regardless of what is drawn or specified shall the completed roofs and/or decks of this project be less restrictive or inferior in any way to these notes and are the minimum standard required. If conflicts exist the higher quality and standard shall apply.
- 3. ROOFING CLASSIFICATION: A Class A Roof is required, unless a more restrictive condition is noted in the drawings and specifications. In extreme high fire zones provide appropriate roofing materials, underlayment and installation details as required by local code or ordinance. Decks are subject to same classification requirements regardless of what is specified within the drawings or specifications.
- 4. FIRE CLASSIFICATION FOR ROOF AND DECKS: Provide roofing and waterproofing that meets with the particular fire zone of the project.
- MINIMUM CODE COMPLIANCE: The completed installation of all roofs, flashing and roof drainage systems shall fully comply with the California Plumbing Code, the California Building Code, The Los Angeles Building Code – most current edition, and all other local, state and federal codes.
- 6. NRCA STANDARDS: In the absence of a specific detail or specification regarding roofing, decks over livable areas and all applicable drainage shall follow the accepted standards of the National Roofing Contractors Association handbook, current edition.
- 7. POSITIVE SLOPE REQUIRED: All Roofing Materials shall be installed with a positive slope to drain. Low Slope Roofs shall have a minimum slope of ½" per foot. Drain wells must have no lip at drain for primary drain and 1" per foot slope within the well.
- 8. DEFLECTION OF STRUCTURAL MEMBERS: Contractor shall verify with the structural engineer the anticipated deflection of supporting materials prior to installation of roof or deck and that deflection shall be approved by the Manufacture of the roofing or decking materials.
- 9. CRICKETS: Provide crickets as required to insure adequate flow of water to drains, gutters, scuppers and away from habitable spaces, etc.
- 10. SECONDARY OVERFLOW: Provide a secondary overflow drainage system for roofs and decks as required by the building and plumbing codes. Verify with Architect the desired method if not detailed, drawn or specified. (Scupper, Secondary / Overflow drain, Gutter, etc.)
- 11. DIMENSIONS: Engineering drawings are often diagrammatic. Dimensions, locations, heights and routes shown on the Architectural drawings shall supersede layouts, dimensions and locations shown on Engineering and Consultant plans or details unless otherwise noted.
- 12. ROOF DRAIN PIPING: All internal roof drain piping shall be cast iron and acoustically isolated from any and all structural components of the building.
- 13. ROOF DRAIN PIPING ROUTES TO STORM DRAIN: All internal roof drains shall be routed inconspicuously or as directed by the Architect or as shown in the drawings. Means and methods of the drain routing shall be the sole responsibility of the General Contractor. General Contractor shall coordinate roof drain locations and drain pipe routing between Architectural and Engineering drawings including floor plans, reflected ceiling plans, electrical and lighting plans, mechanical and ductwork layouts, all plumbing fixtures and piping, all structural members and other required or decorative elements of the project. The Architect, prior to any roof drainage piping or drain installation, shall approve of the route and any and all deviations from the drawings or specifications.
- 14. ROOFING AND DECKING: Provide to the Architect a complete, fully detailed submittal including samples, manufacturer's specifications and proposed guarantees for any roofing, deck waterproofing, flashing or drainage component to be used on this project, a minimum of 14 days prior to the REQUIRED Pre-Roofing Conference to be held on site BEFORE ANY materials are purchased or delivered.
- 15. PRE-ROOFING CONFERENCE: A Pre-Roofing Conference is required and shall be attended by the Owner or Owners representative, the Architect, Roofing Consultant, the General Contractor, project manager and superintendent, the roofer's superintendent and/or foreman who will be on the job, and the manufacturer's representative. This is mandatory, no exceptions.
- 16. ROOF APPLICATORS EXPERIENCE REQUIREMENTS: All roofs shall be installed by applicators with a minimum of five years experience-installing materials of types specified and shall have successfully completed at least five projects of similar scope and complexity.
- 17. QUALITY CONTROL: Quality control is the Roofing Sub-Contractors responsibility and obligation. Poor quality observed or as a result of post installation testing by the Architect, Roofing Consultant or General Contractor will be removed and replaced at Roofing Sub-Contractors own expense.

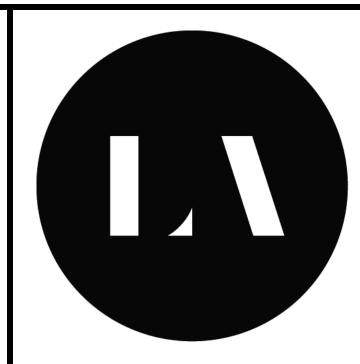

LANEY LA

LIFESTYLE + ARCHITECTURE

PROJECT NAME
THE STRAND PALACE

PROJECT NUMBER

6087

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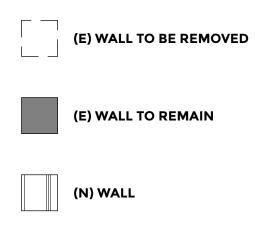
**ROOF PLAN** 

### WALL ASSEMBLY SCHEDULE

### (N) 5/8" GYP BRD (N) 2X4 STUD WALL @ 16" O.C. (N) 5/8" GYP BRD (N) WOOD SIDING TO REPLACE, BUT NOT TO EXCEED WIDTH OF (E) SIDING (E) PLYWOOD TO REMAIN (E) 2X6 STUD WALL @ 16" O.C. (N) 5/8" GYP BRD (N) STONE VENEER TO REPLACE, BUT NOT TO EXCEED WIDTH OF (E) STONE VENEER (E) PLYWOOD TO REMAIN (E) 2X6 STUD WALL @ 16" O.C.

(N) 5/8" GYP BRD

### **WALL LEGEND**




# TO ABOVE

BEACH LEVEL RCP / POWER SIGNAL PLAN

SCALE: 1/4" = 1'-0"

2

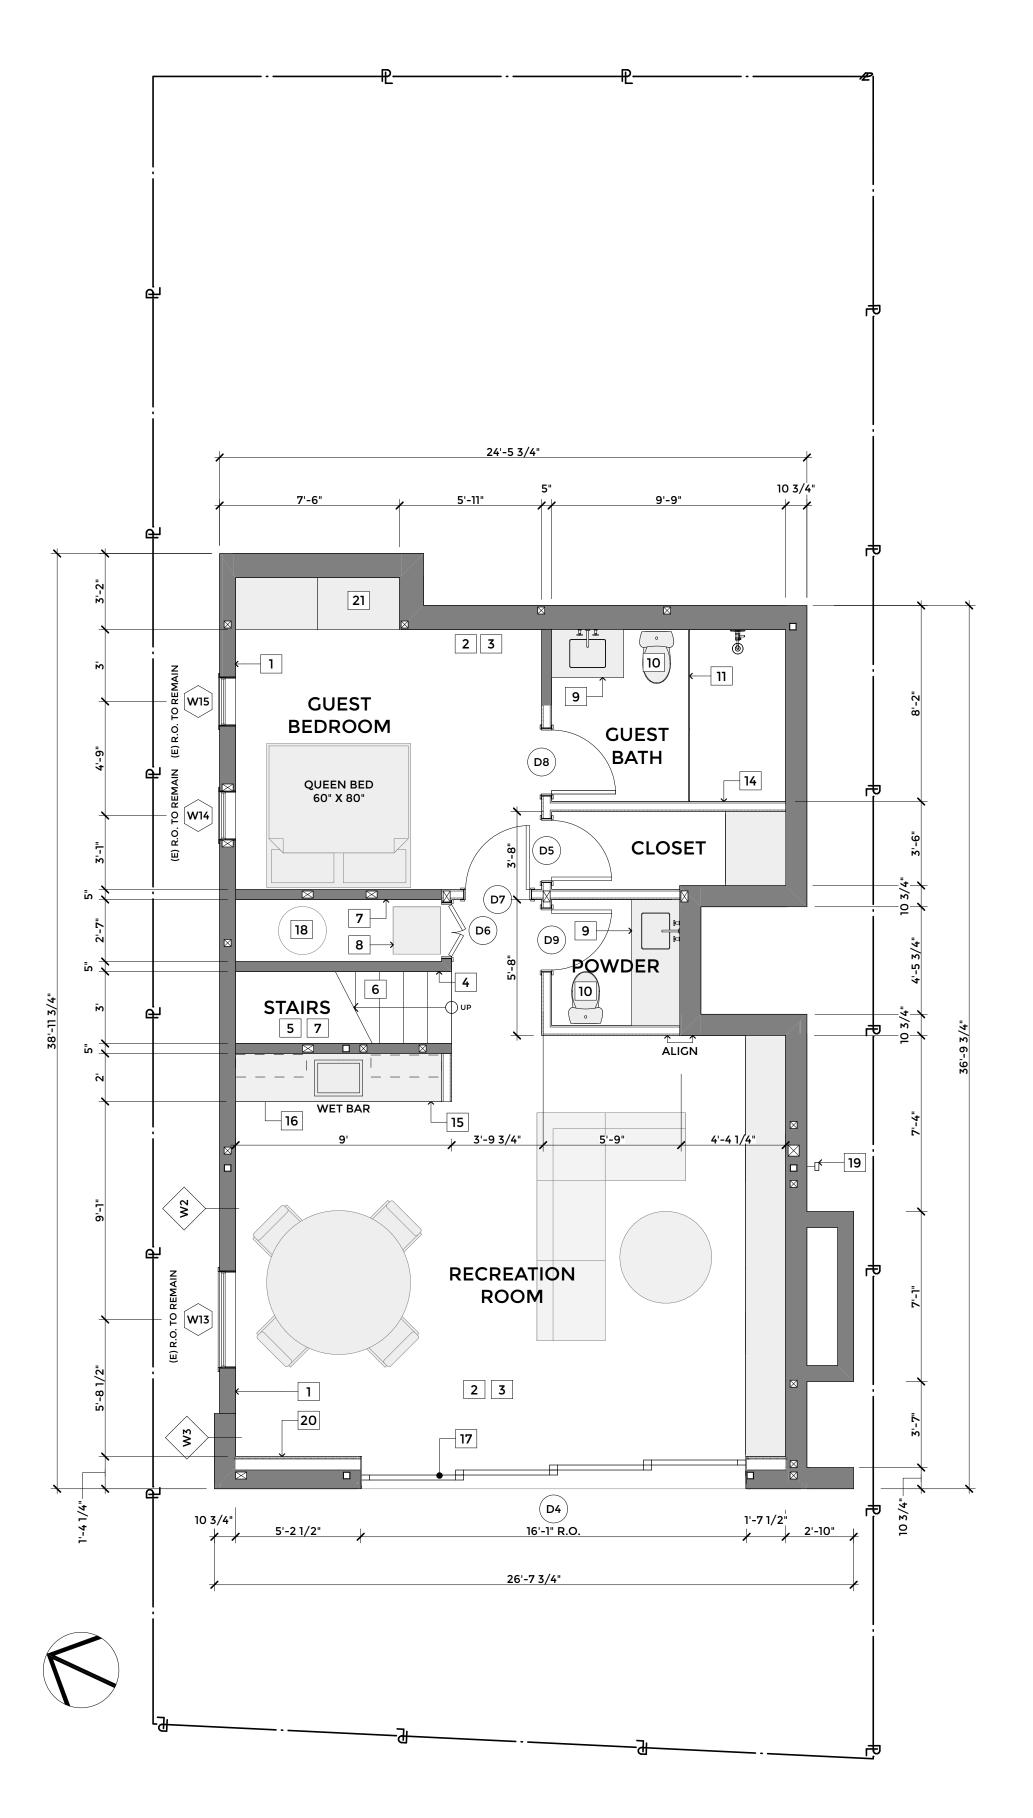

# BEACH FLOOR PLAN SCALE: 1/4" = 1'-0"



### **BEACH FLOOR KEYNOTES**

- PANELED WAINSCOTTING, TYP.
- POSSIBLE FURR DOWN @ PERIMETER FOR DUCTING
- COVE MOULDING @ PERIMETER OF ROOM
- 4 34" HIGH WOOD HANDRAIL SEE DETAIL
- SEE DETAILS FOR WOOD FRAMING CONSTRUCTION @ STAIRS
- 12" TREADS AS SHOWN
- PROVIDE ONE-HOUR CONSTRUCTION UNDER STAIRS, USE 5/8" TYPE-X GYPBOARD @ WALLS AND CEILING
- STACKED WASHER/DRYER
- LAVATORY AND BASE CABINET WITH COUNTERTOP AND BACKSPLASH
- WATER CLOSET SELECTED BY OWNER
- FRAMELESS TEMPERED GLASS ENCLOSURE
- THICKEN WALL @ THIS LOCATION
- SOAP NICHE AND PLUMBING @ WALL
- BUILT-IN WET BAR WITH BASE CABINETS, DISHWASHER, AND MINI FRIDGE
- UPPER CABINETS ABOVE WET BAR
- (N) SLIDING DOORS
- (E) SEWAGE EJECTION PUMP
- (E) OUTDOOR SHOWER TO REMAIN
- (E) WALL TO BE FURRED OUT TO ACCOMMODATE WIDTH OF SLIDING DOORS
- 21 (N) BUILT IN CABINETS WITHIN (E) OPENING

### **ELECTRICAL SYMBOL KEY**

LXX	RECESSED ROUND ADJUSTABLE DOWNLIGHT
LXX	SPECIALITY CAN LIGHTS
LXX	DECORATIVE WALL-MOUNTED FIXTURE
LXX •	DECORATIVE CEILING-MOUNTED FIXTURE
- LXX	LINEAR LOW-VOLTAGE FIXTURE
LXX	LINEAR FLUORESCENT FIXTURE
LXX	EXHAUST FAN
$\oplus$	WALL OUTLET
GFI	GFI OUTLET
UC-GFI	UNDER COUNTER GFI OUTLET
<b></b>	220 V OUTLET
	FLOOR OUTLET
<del>()</del>	SWITCH
3	3-WAY SWITCH
\$ <sub>GD</sub>	GARBAGE DISPOSAL SWITCH
	STRIP OUTLETS
SD	SMOKE/CARBON MONOXIDE DETECTOR  (PROVIDE HARD WIRED AND INTERCONNECTED SMOKE/ CARBON MONOXIDE DETECTOR WITH BATTERY BACK-UP ADJACENT TO AND INSIDE BEDROOMS. BATTERY OPERATED IS ACCEPTABLE IN EXISTING AREAS.)



**LANEY LA** 

LIFESTYLE + ARCHITECTURE

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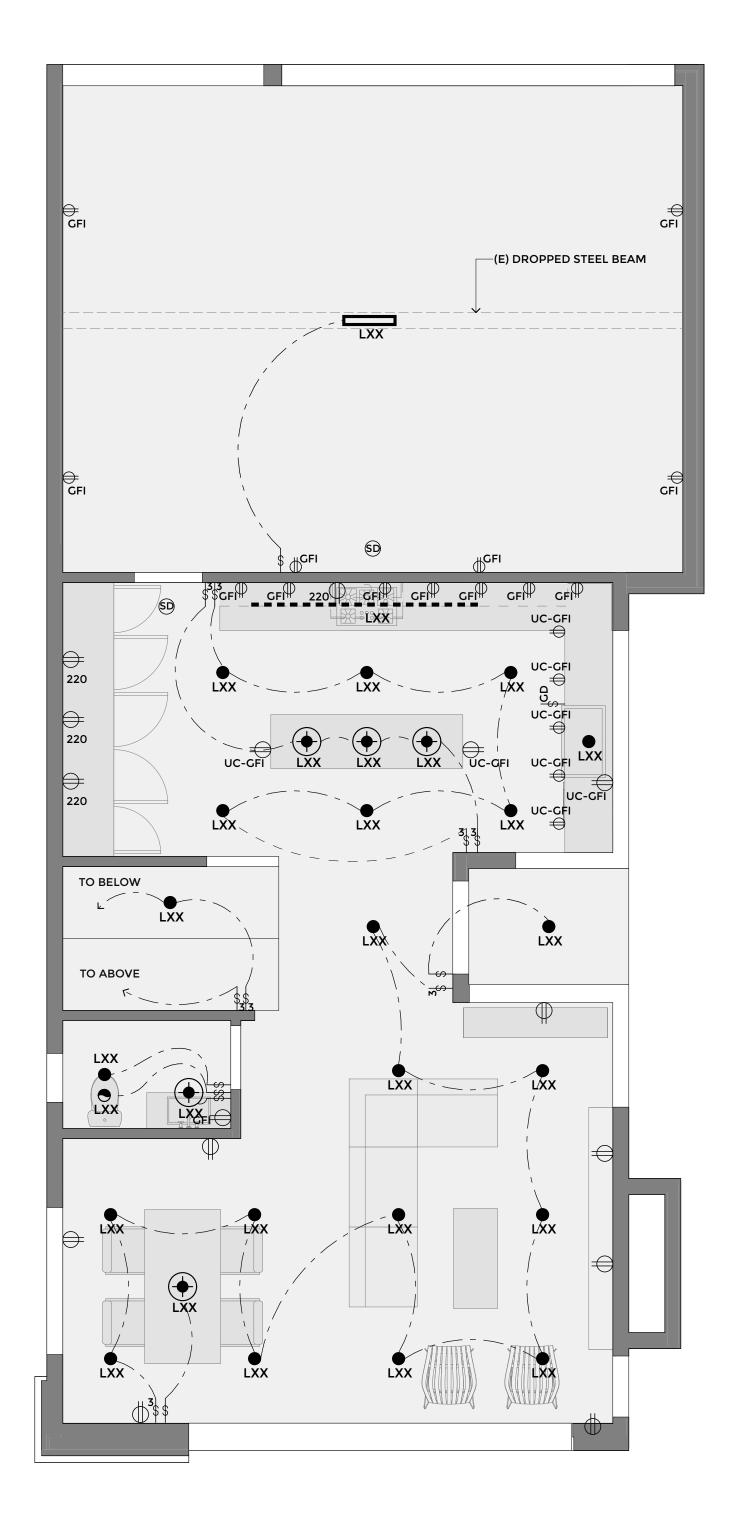


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FLOOR PLAN & RCP -**BEACH LEVEL** 



# FIRST FLOOR RCP / POWER SIGNAL PLAN SCALE: 1/4" = 1'-0" 2

### WALL ASSEMBLY SCHEDULE

W1

(N) 5/8" GYP BRD

(N) 2X4 STUD WALL @ 16" O.C.

(N) 5/8" GYP BRD

W2

(N) WOOD SIDING TO REPLACE, BUT NOT TO EXCEED WIDTH OF (E) SIDING

(E) PLYWOOD TO REMAIN

(E) 2X6 STUD WALL @ 16" O.C.

(N) 5/8" GYP BRD

W3


(N) STONE VENEER TO REPLACE, BUT NOT TO EXCEED WIDTH OF (E) STONE VENEER


(E) PLYWOOD TO REMAIN

(E) 2X6 STUD WALL @ 16" O.C.

(N) 5/8" GYP BRD

### **WALL LEGEND**

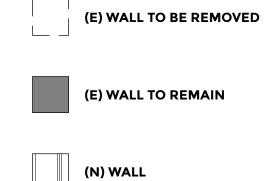

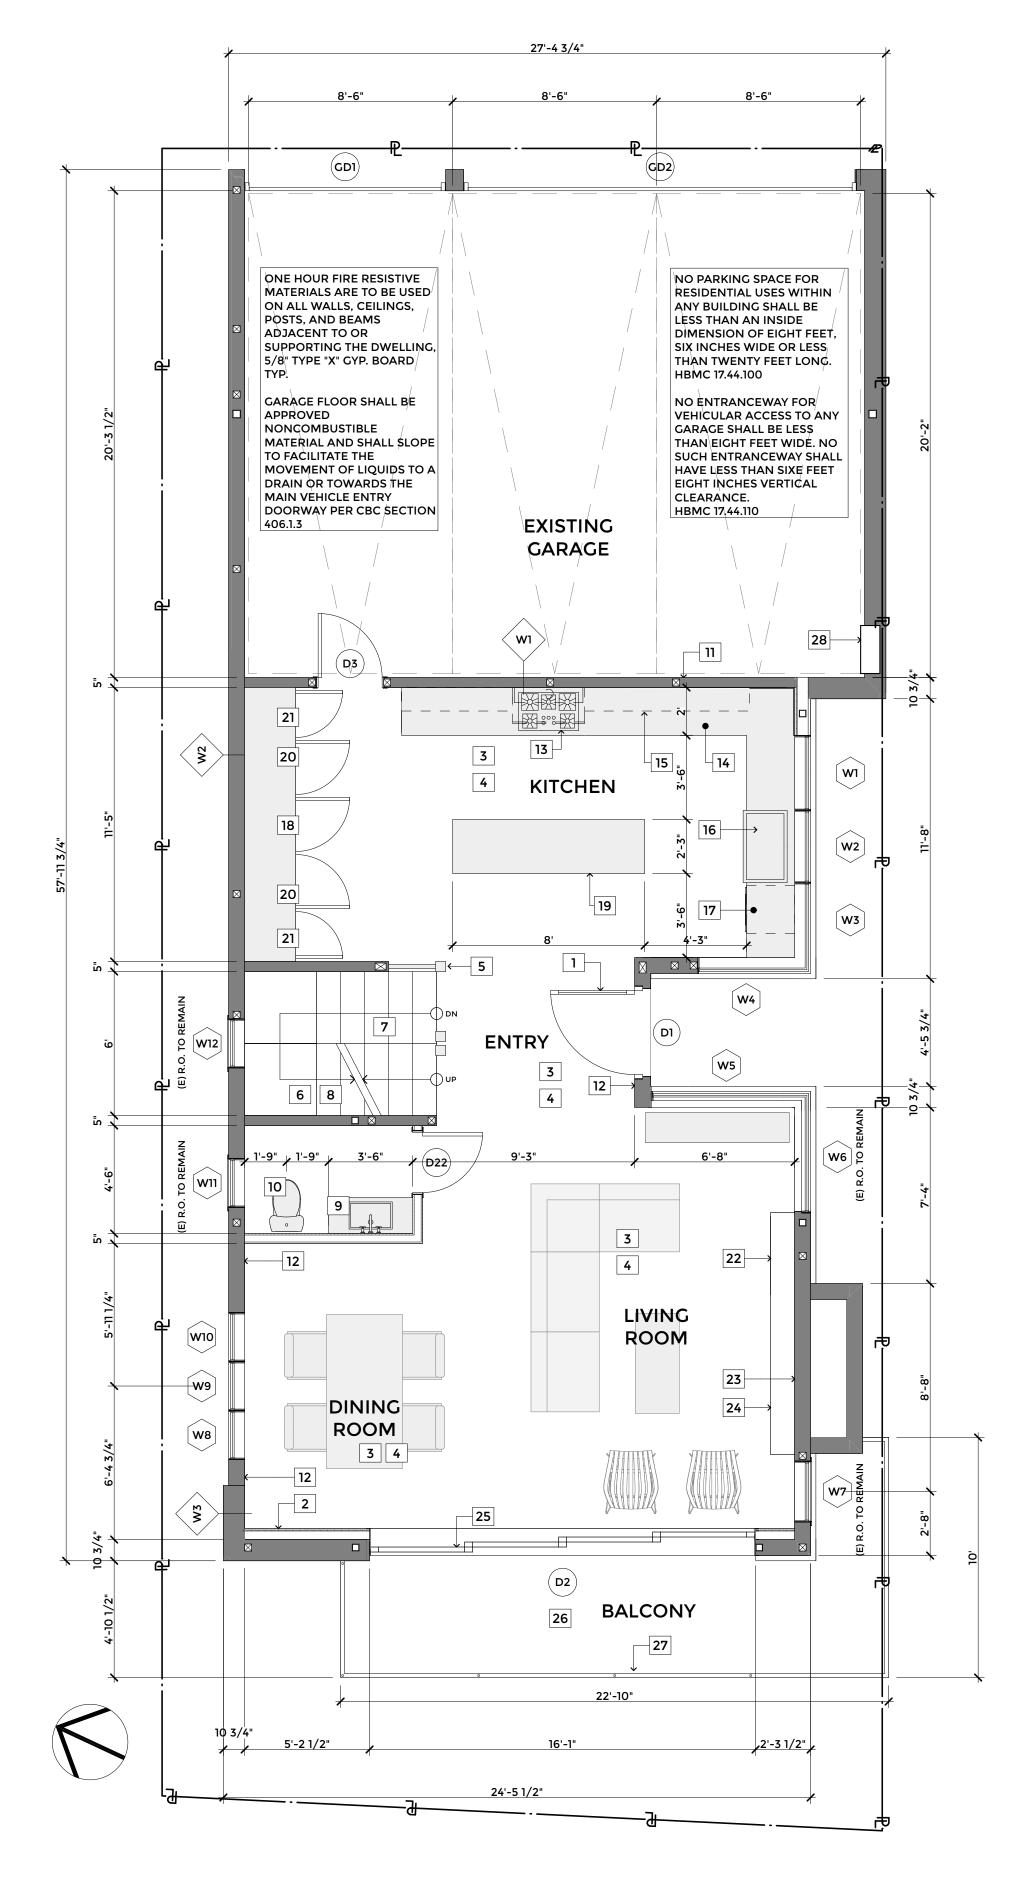

### FIRST FLOOR PLAN

### **1ST FLOOR KEYNOTES**

### **ENTRY, POWDER ROOM**

- 1 (N) ENTRY DOOR
- (E) WALL TO BE FURRED OUT TO ACCOMMODATE
- WIDTH OF SLIDING DOORS

  POSSIBLE FURR DOWN @ PERIMETER FOR
- DUCTING
- 4 COVE MOULDING @ PERIMETER OF ROOM
- 34" HIGH WOOD RAILING W/ INTERMEDIATE RAILS, SEE A-22/9
- SEE DETAILS FOR WOOD FRAMING CONSTRUCTION @ STAIRS
- 7 12" TREADS AS SHOWN
- PROVIDE ONE-HOUR CONSTRUCTION UNDER STAIRS, USE 5/8" TYPE-X GYPBOARD @ WALLS AND CEILING
- 9 LAVATORY AND BASE CABINET WITH COUNTERTOP AND BACKSPLASH
- WATER CLOSET SELECTED BY OWNER
- PROVIDE ONE-HOUR TYPE-X GYPBOARD @ WALLS AND CEILING
- 12 PANELED WAINSCOTTING

### **KITCHEN**

- GAS RANGE/OVEN UNIT WITH OVERHEAD HOOD, CONSULT WITH OWNER FOR SPECIFICATION
- STONE COUNTERTOP TYP. WITH CABINETRY
- 15 OUTLINE OF CABINETS ABOVE
- 16 UNDERMOUNT SINK WITH GARBAGE DISPOSAL
- 17 DISHWASHER SPACE
- WINE REFRIGERATOR CONSULT WITH OWNER FOR SPECIFICATION
- 36" HIGH ISLAND WITH SPACE BELOW FOR BAR STOOLS
- BUILT-IN REFRIGERATOR AND FREEZER W/ WATER LINE - SELECTED BY OWNER
- 21 FULL HEIGHT PANTRY

### LIVING ROOM, DINING ROOM, BALCONY

- BUILT-IN BOOKCASE WITH FULL HEIGHT SHELVING
- (N) METAL FIREPLACE WITH 36" WIDE OPENING @ FINISHED FLOOR
- 20" STONE HEARTH CONSULT W/ OWNER FOR POSSIBLE RAISED HEARTH
- 25 (N) SLIDING DOORS
- (N) APPLIED WATERPROOF MEMBRANE OVER (E) DECK JOISTS
- 27 42" HIGH GLASS GUARDRAIL, SEE A-24/5

### GARAGE

28 TANKLESS HOT WATER HEATER

### **ELECTRICAL SYMBOL KEY**

LXX	RECESSED ROUND ADJUSTABLE DOWNLIGHT
LXX	SPECIALITY CAN LIGHTS
LXX	DECORATIVE WALL-MOUNTED FIXTURE
LXX	DECORATIVE CEILING-MOUNTED FIXTURE
- <u>-</u> -	LINEAR LOW-VOLTAGE FIXTURE
LXX	LINEAR FLUORESCENT FIXTURE
LXX	EXHAUST FAN
<b></b>	WALL OUTLET
GFI	GFI OUTLET
UC-GFI	UNDER COUNTER GFI OUTLET
<b></b>	220 V OUTLET
	FLOOR OUTLET
\$	SWITCH
3 \$	3-WAY SWITCH
\$ <sub>GD</sub>	GARBAGE DISPOSAL SWITCH
	STRIP OUTLETS
(SD)	SMOKE/CARBON MONOXIDE DETECTOR  (PROVIDE HARD WIRED AND INTERCONNECTED SMOKE/ CARBON MONOXIDE DETECTOR WITH BATTERY BACK-UP ADJACENT TO AND INSIDE BEDROOMS. BATTERY OPERATED IS ACCEPTABLE IN EXISTING AREAS.)



LANEY LA

LIFESTYLE + ARCHITECTURE

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PROJECT NUMBER

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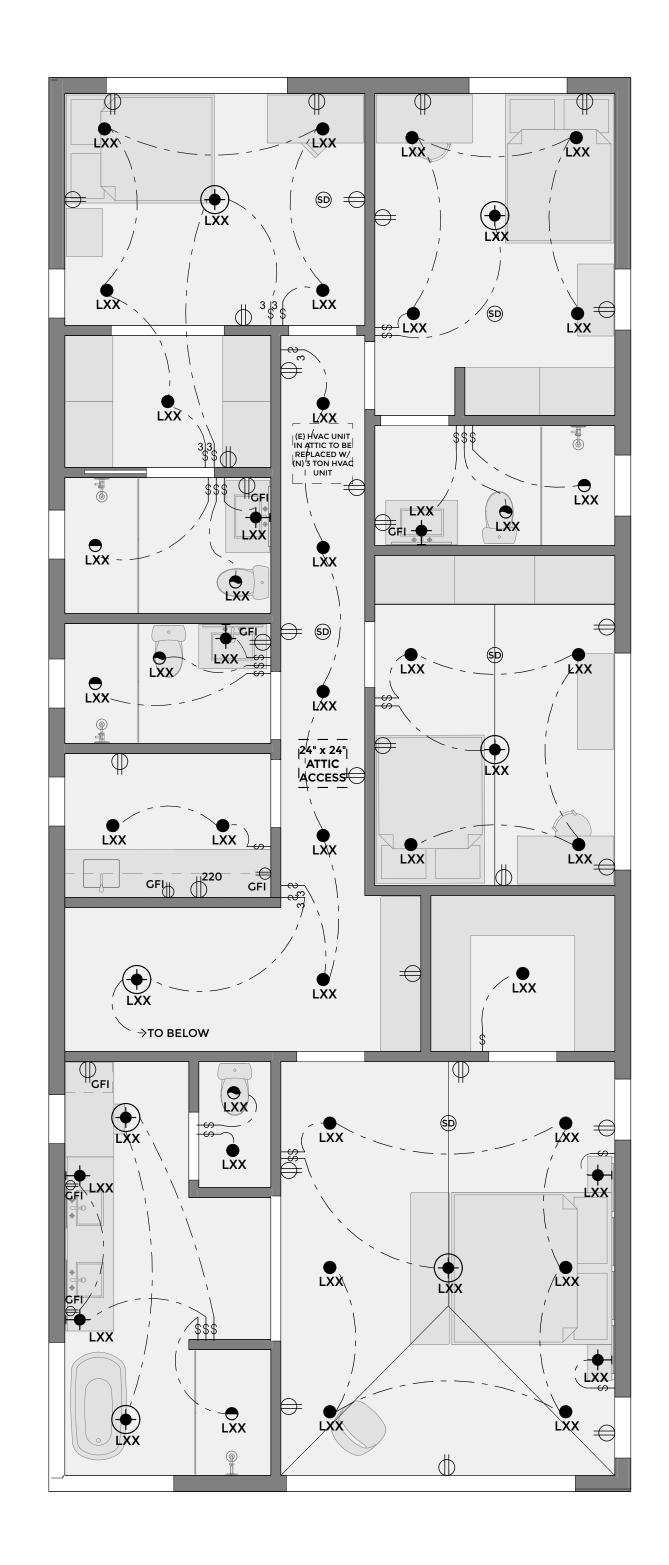
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SHEET TITLE

FLOOR PLAN & RCP -FIRST FLOOR



# SECOND FLOOR RCP / POWER SIGNAL PLAN SCALE: 1/4" = 1'-0" 2

### WALL ASSEMBLY SCHEDULE

W1

(N) 5/8" GYP BRD
(N) 2X4 STUD WALL @ 16" O.C.
(N) 5/8" GYP BRD

W2

(N) WOOD SIDING TO REPLACE, BUT NOT TO EXCEED WIDTH OF (E) SIDING
(E) PLYWOOD TO REMAIN
(E) 2X6 STUD WALL @ 16" O.C.
(N) 5/8" GYP BRD


W3


(N) STONE VENEER TO REPLACE, BUT NOT TO EXCEED WIDTH OF (E) STONE VENEER

(E) PLYWOOD TO REMAIN

(E) 2X6 STUD WALL @ 16" O.C. (N) 5/8" GYP BRD

### WALL LEGEND

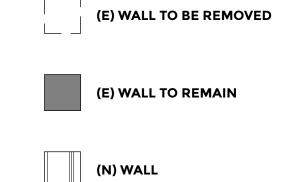

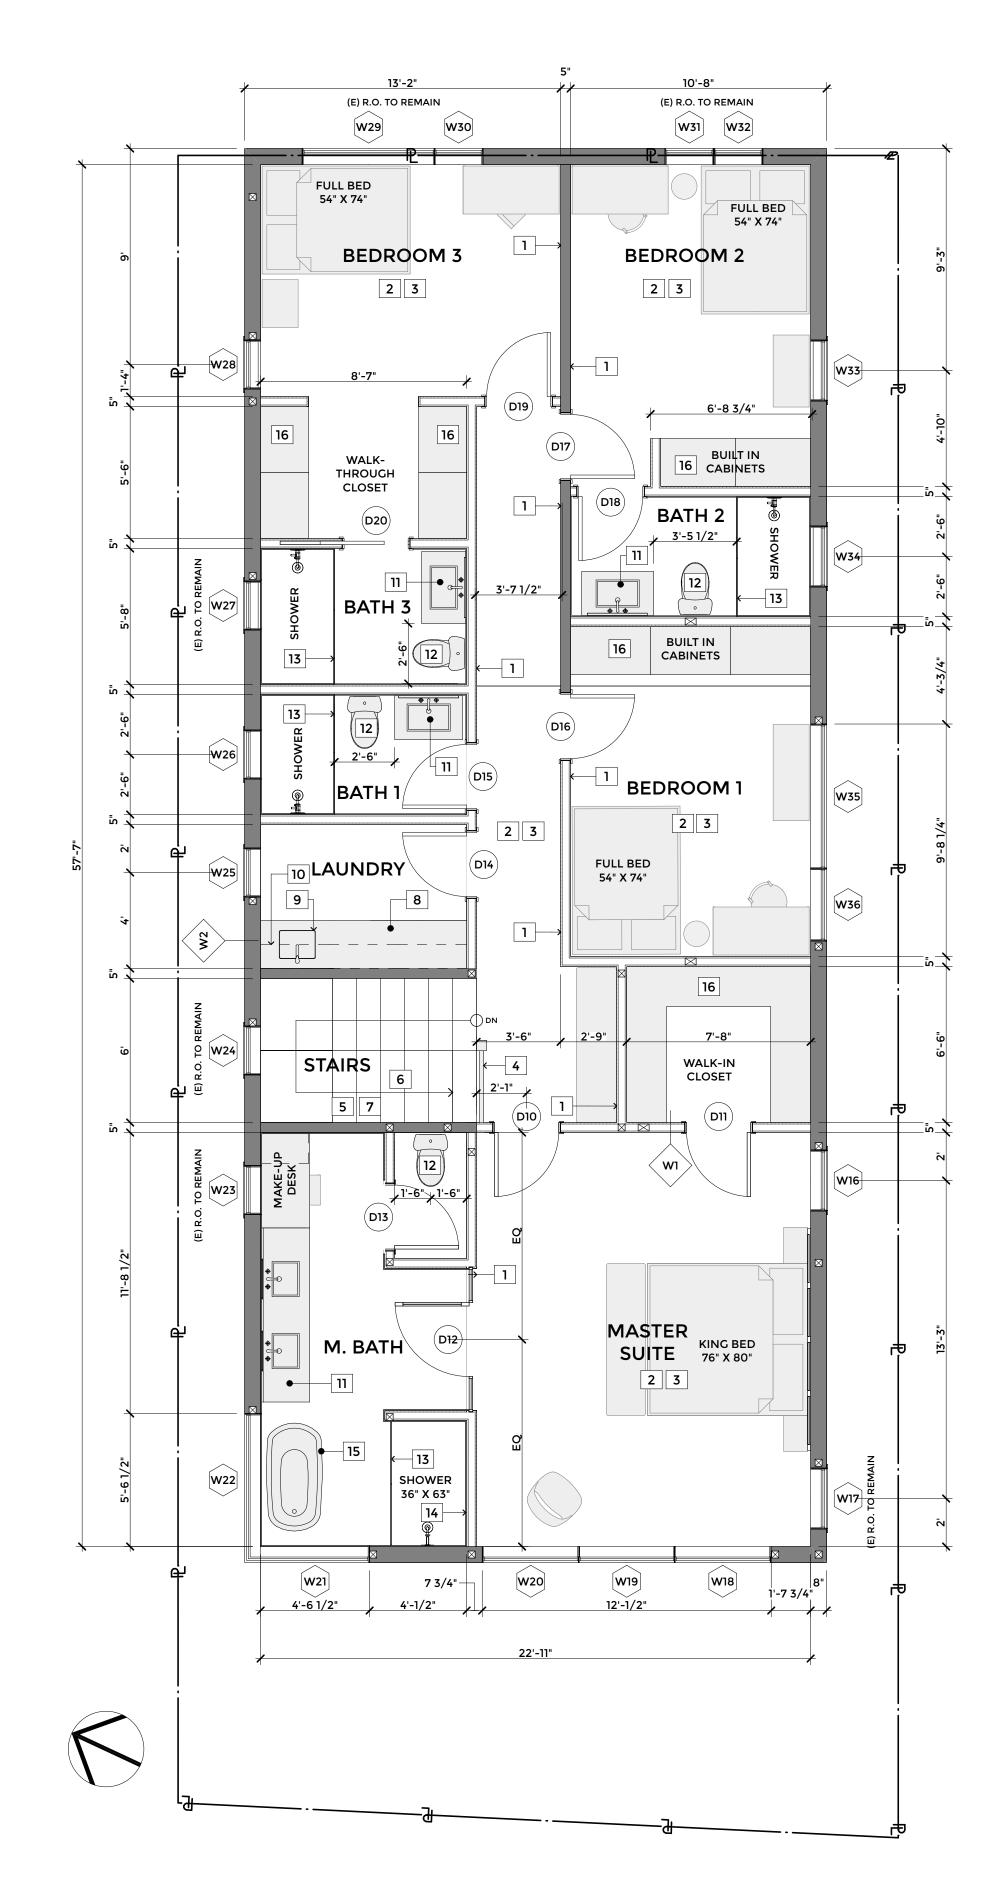

## SECOND FLOOR PLAN SCALE: 1/4" = 1'-0"

### **2ND FLOOR KEYNOTES**

### LAUNDRY ROOM, STAIRS

- 1 PANELED WAINSCOTTING
- POSSIBLE FURR DOWN @ PERIMETER FOR DUCTING
- COVE MOULDING @ PERIMETER OF ROOM
- 4 34" HIGH WOOD RAILING W/ INTERMEDIATE RAILS, SEE A-22/9
- SEE SD-1/8 FOR WOOD FRAMING CONSTRUCTION @ STAIRS
- 6 12" TREADS AS SHOWN
- PROVIDE ONE-HOUR CONSTRUCTION UNDER STAIRS, USE 5/8" TYPE-X GYPBOARD @ WALLS AND CEILING
- 8 SIDE-BY-SIDE WASHER/DRYER
- 9 LAVATORY AND BASE CABINET WITH COUNTERTOP AND BACKSPLASH
- 10 UPPER CABINETS ABOVE

### BEDROOMS, BATHROOMS, CLOSETS

- LAVATORY AND BASE CABINET WITH COUNTERTOP AND BACKSPLASH
- 12 WATER CLOSET SELECTED BY OWNER
- 13 FRAMELESS TEMPERED GLASS ENCLOSURE
- TILED SHOWER W/ RECESSED SHAMPOO SHELF 5' ABOVE FLOOR
- 15 FREE-STANDING TUB SELECTED BY OWNER
- 16 CLOSET SHELVING CONSULT WITH OWNER

### **ELECTRICAL SYMBOL KEY**

LXX	RECESSED ROUND ADJUSTABLE DOWNLIGHT
LXX	SPECIALITY CAN LIGHTS
LXX	DECORATIVE WALL-MOUNTED FIXTURE
LXX	DECORATIVE CEILING-MOUNTED FIXTURE
- LXX	LINEAR LOW-VOLTAGE FIXTURE
LXX	LINEAR FLUORESCENT FIXTURE
LXX	EXHAUST FAN
Ф	WALL OUTLET
GFI	GFI OUTLET
UC-GFI	UNDER COUNTER GFI OUTLET
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### LANEY LA

LIFESTYLE + ARCHITECTURE

### PROJECT NAME

THE STRAND PALACE

PROJECT NUMBER

### 0007

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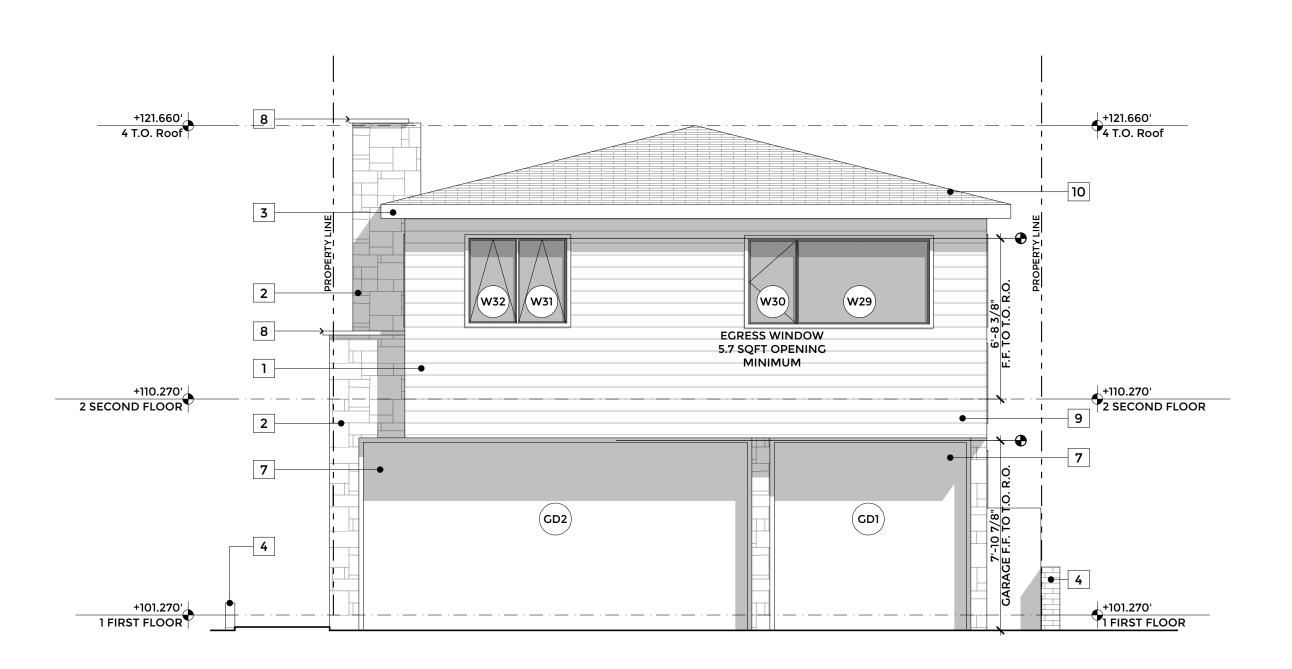


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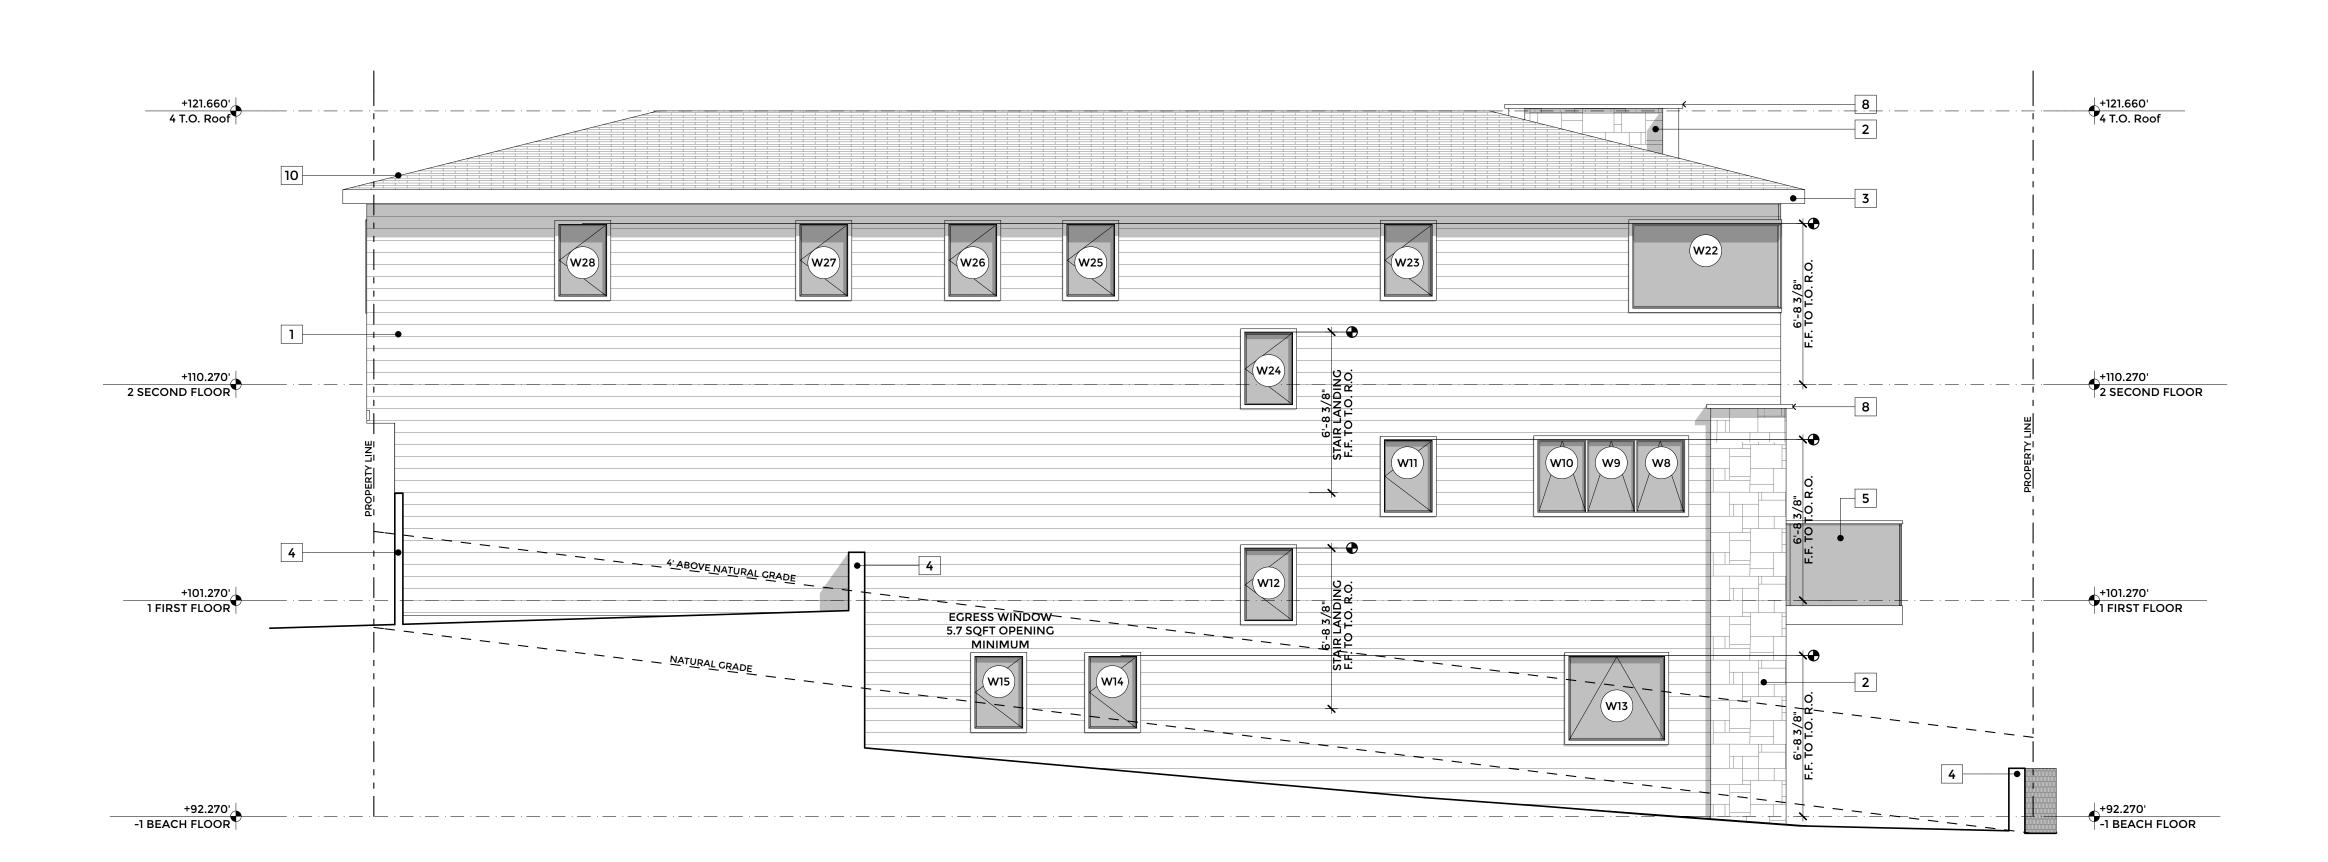
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FLOOR PLAN & RCP - SECOND FLOOR









### **ELEVATION KEYNOTES**

- (E) SHINGLE SIDING TO BE REPLACE, COLOR T.B.D., WALL TO REMAIN STRUCTURALLY INTACT
- (E) STONE VENEER TO BE REPLACED W/ (N) STONE VENEER
- 3 (N) WOOD FASCIA TO BE PAINTED, COLOR T.B.D.
- (E) RETAINING WALL TO REMAIN, (E) MATERIALS TO REMAIN
- 5 42" GLASS RAIL
- 6 (N) STORAGE AREA
- 7 (N) ROLL-UP GARAGE DOORS W/ REMOTE OPENER, (E) R.O. TO REMAIN
- (E) STONE CAP TO BE REPLACED W/ (N) STONE CAP
- 9 (E) DROPPED BEAM TO REMAIN
- 10 (N) ASPHALT SHINGLES OVER (E) ROOF RAFTERS



LANEY LA

LIFESTYLE + ARCHITECTURE

PROJECT NAME
THE STRAND PALACE

PROJECT NUMBER 16087

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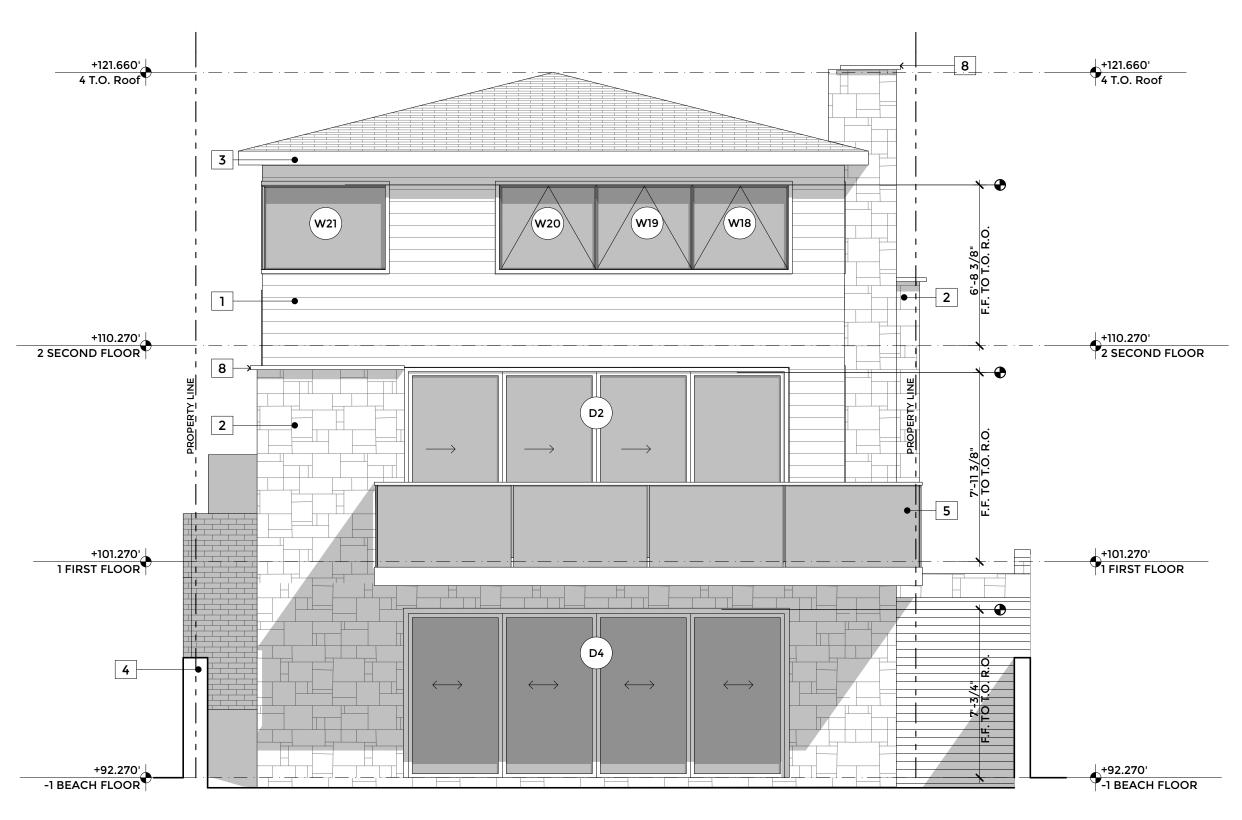


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SHEET TITLE

**ELEVATIONS** 









### **ELEVATION KEYNOTES**

- (E) SHINGLE SIDING TO BE REPLACE, COLOR T.B.D., WALL TO REMAIN STRUCTURALLY INTACT
- (E) STONE VENEER TO BE REPLACED W/ (N) STONE VENEER
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LANEY LA

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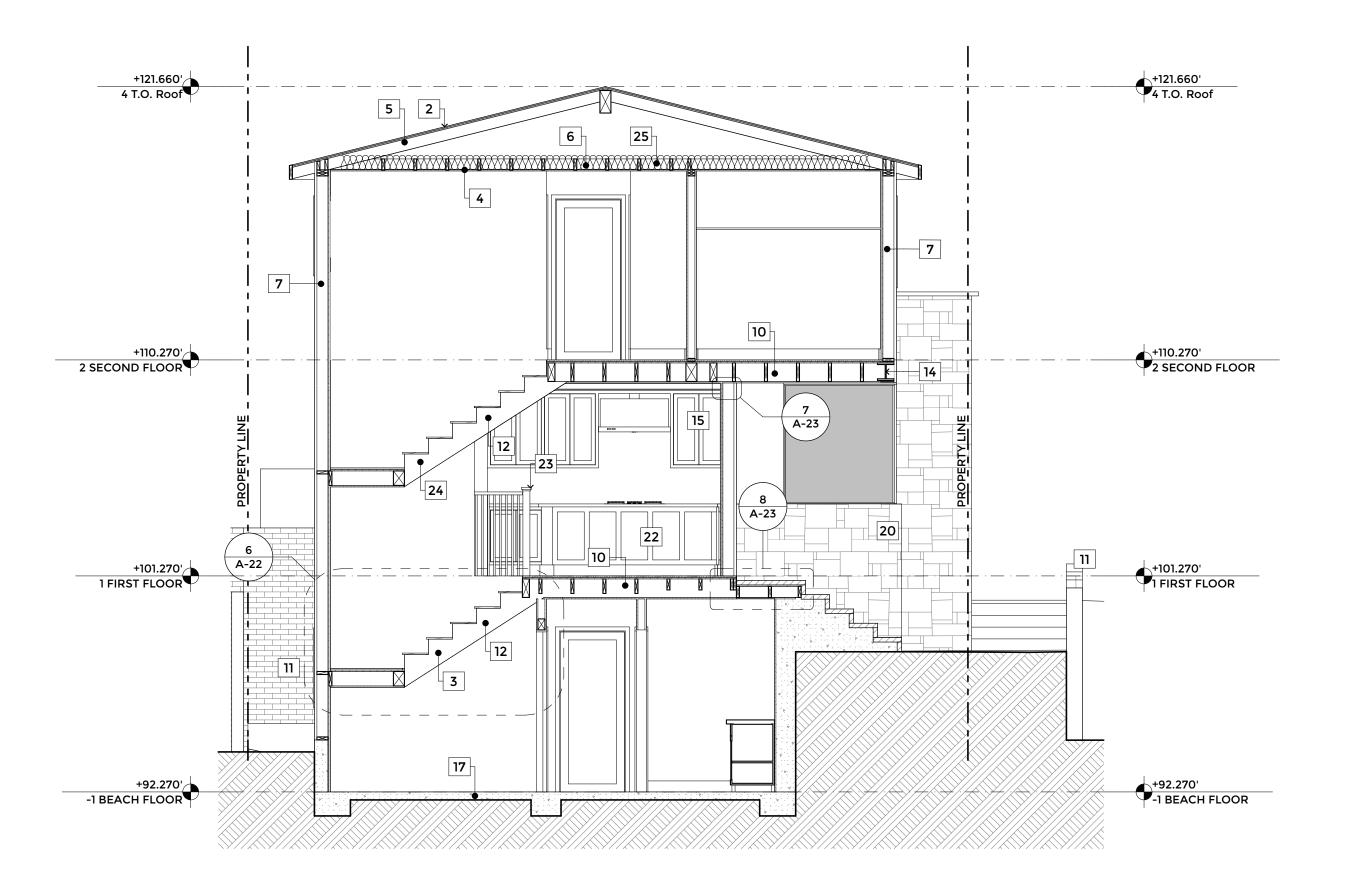
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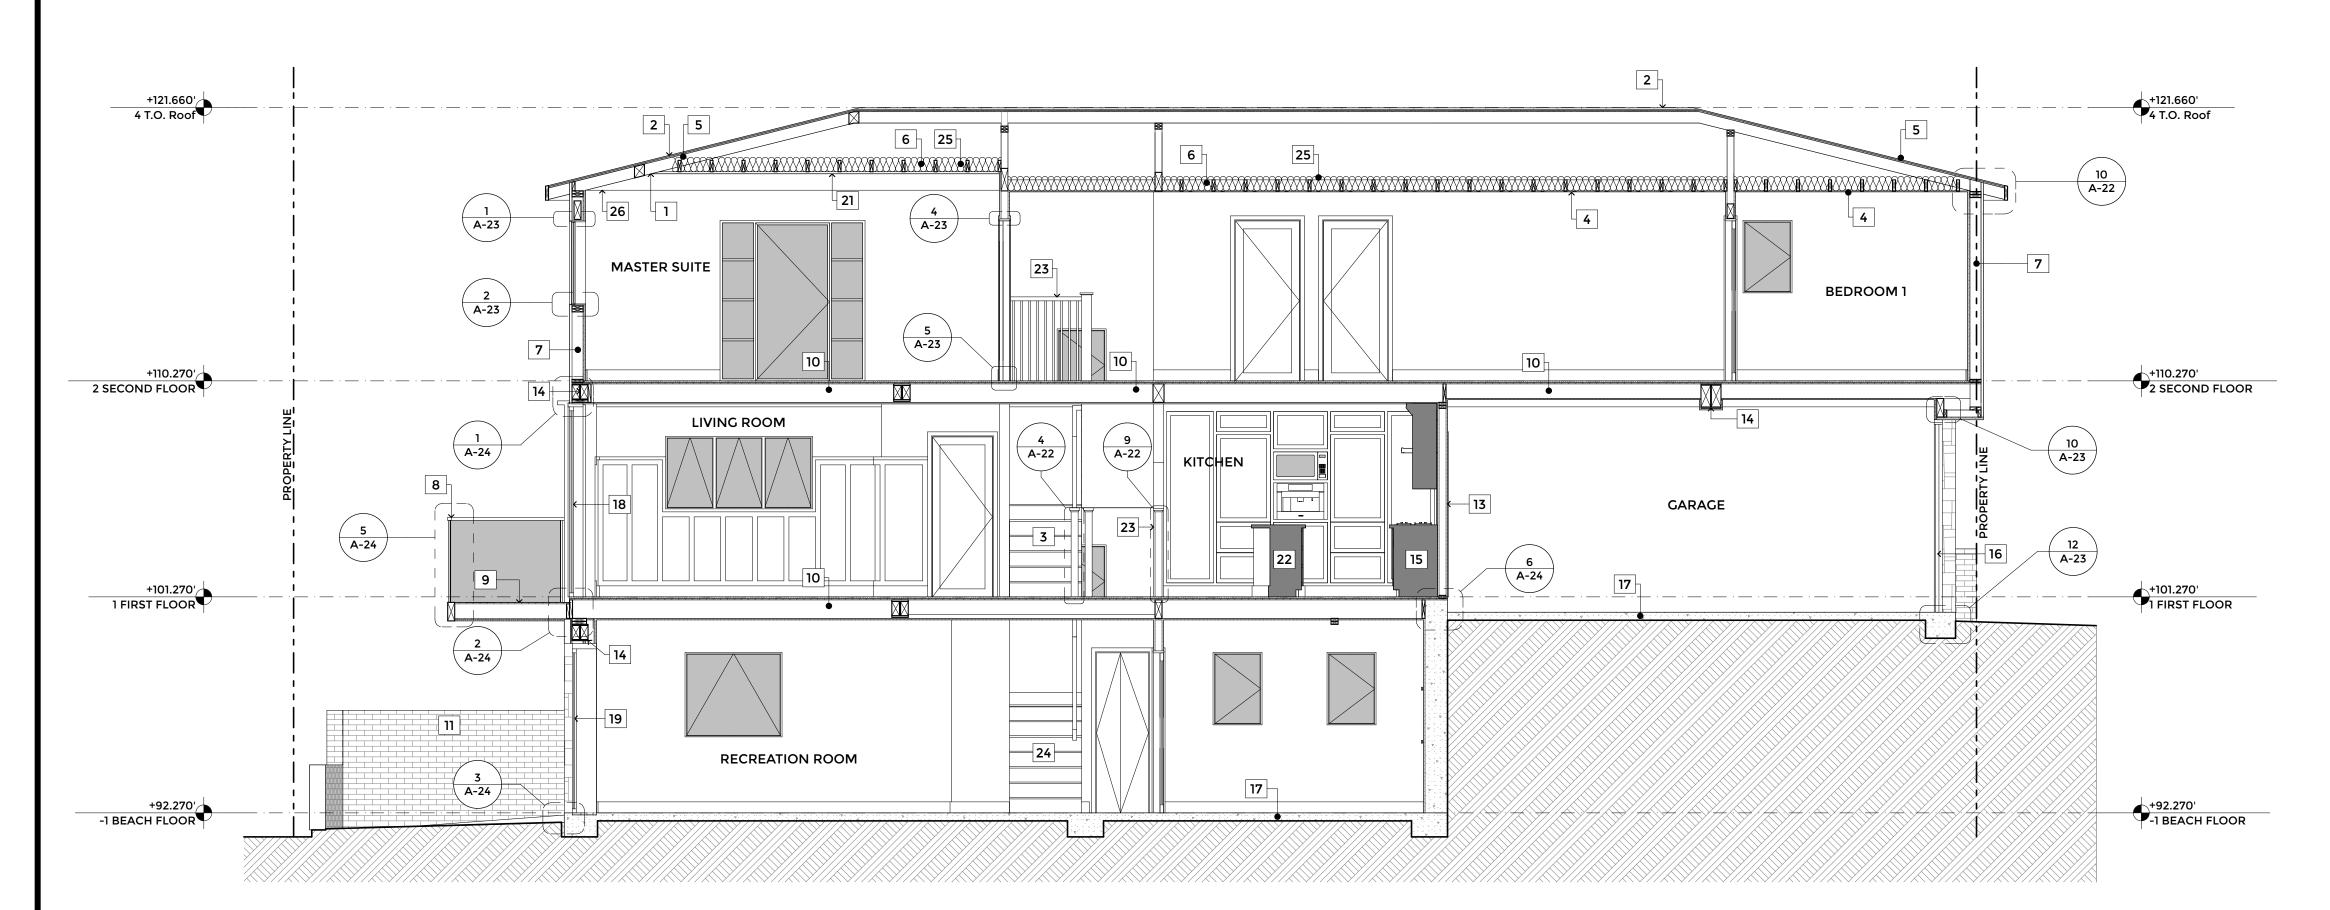
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**ELEVATIONS** 







LONG SECTION

SCALE: 1/4" = 1'-0"

### **SECTION KEYNOTES**

- 1 CLIPPED CEILING, SEE FRAMING PLAN
- 2 (N) ASPHALT SHINGLES OVER (E) ROOF RAFTERS
- 3 (N) WOOD STAIRS
- 4 DROPPED CEILING
- 5 ROOF RAFTER/JOIST, SEE FRAMING PLAN
- 6 CEILING JOIST, TYP.
- 7 2X STUD WALL
- 8 GUARDRAIL ASSEMBLY
- 9 DECK FINISH OVER WATERPROOF MEMBRANE
- 10 FLOOR JOIST, TYP.
- (E) SITE WALL TO REMAIN, (E) MATERIALS TO REMAIN
- 12 STRINGERS AT STAIRS, SEE DETAIL SD1-8
- 5/8" TYPE-X GYPBOARD @ GARAGE WALLS AND CEILING
- 14 STEEL BEAMS, SEE FRAMING PLAN
- 15 BUILT-IN CABINETRY
- 16 SECTIONAL ROLL-UP GARAGE DOOR
- 17 CONCRETE SLAB ON GRADE
- 18 (N) STACKING DOORS
- 19 (N) SLIDING DOORS
- 20 (N) STONE VENEER
- 21 (N) VAULTED CEILING
- 22 KITCHEN ISLAND
- 23 INTERIOR GUARDRAIL, SEE DETAIL
- 24 (E) STAIRS
- 25 R-30 BATT INSULATION
- 26 (N) EXPOSED BEAMS



LANEY LA

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