### ARCHITECT'S STATEMENT

**OVERLAPPING AND CONFLICTING REQUIREMENTS:** WHERE COMPLIANCE WITH TWO OR MORE INDUSTRY STANDARDS OR SETS OF REQUIREMENTS IS SPECIFIED. AND OVERLAPPING OF THOSE DIFFERENT STANDARDS OR REQUIREMENTS ESTABLISHES DIFFERENT OR CONFLICTING MINIMUMS OR LEVELS OF QUALITY. THE MOST STRINGENT (WHICH IS GENERALLY RECOGNISED AS THE MOST COSTLY) IS THE INTENDED STANDARD AND IS THE ONE CONTACT: THAT SHALL BE ENFORCED, UNLESS SPECIFICALLY NOTED OTHERWISE REFER DIFFERENT BUT OTHERWISE APPARENTLY EQUAL STANDARDS TO THE ARCHITECT/ENGINEER BEFORE PROCEEDING.


MINIMUM QUALITY/QUANTITY:

IN EVERY INSTANCE: QUALITY LEVEL OR QUANTITY SHOWN OR SPECIFIED IS INTENDED AS A MINIMUM FOR THE WORK TO BE PERFORMED OR PROVIDED. EXCEPT AS NOTED OTHERWISE ACTUAL WORK MAY EITHER COMPLY EXACTLY OR MAY EXCEED THAT MINIMUM WITHIN REASONABLE LIMITS. IN COMPLYING WITH REQUIREMENTS, INDICATED NUMERIC VALUES ARE EITHER MINIMUMS OR MAXIMUMS AS NOTED OR AS APPROPRIATE FOR THE CONTEXT GIVEN. REFER INSTANCES OF UNCERTAINTY TO ARCHITECT/ENGINEER FOR CLARIFICATION BEFORE PROCEEDING.

### NOTE TO CONTRACTOR:

WHERE CONTRACT DOCUMENTS (DRAWINGS AND SPECIFICATIONS) ARE INCOMPLETE, AMBIGUOUS OR CONTAIN CONFLICTING INSTRUCTIONS. DO NOT PROCEED UNTIL RECEIVING CLARIFICATION FROM THE ARCHITECT IN WRITING. THE 3. CONTRACTOR SHALL BE RESPONSIBLE FOR ALL BUILDING SYSTEMS, NEW AND EXISTING TO REMAIN. ALL STRUCTURAL, ELECTRICAL, MECHANICAL, PLUMBING ETC.. SHALL BE IN GOOD WORKING ORDER WHEN TURNED OVER TO THE OWNER.

### VICINITY MAP

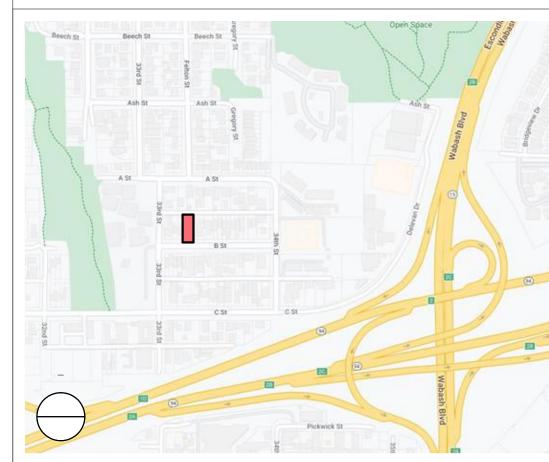

### PROJECT INFORMATION

PROJECT NAME: OWNER: ADDRESS: EMAIL: PROJECT ADDRESS: SAN DIEGO, CA 92102

ASSESSOR PARCEL NUMBER(S): 540 - 590 - 2900

### SCOPE OF WORK

- 1. DEMOLISH EXISTING SHED STRUCTURE. UNDER SEPARATE PERMIT 2. NEW CONSTRUCTION OF 3-STORY, PRIVATELY FUNDED, FOR-RENT RESIDENTIAL BUILDING WITH TWELVE (9) ACCESSORY DWELLING UNITS. DENSITY IS PERMITTABLE WITH SDHC ADU BONUS PROGRAM. ALL LEVELS ARE TYPE VB CONSTRUCTION.
- 4. R-2 OCCUPANCY IN ACCORDANCE WITH REQUIREMENTS OF CBC CHAPTER

## CODE COMPLIANCE

2022 CALIFORNIA BUILDING CODE 2022 CALIFORNIA ELECTRICAL CODE 2022 CALIFORNIA PLUMBING CODE 2022 CALIFORNIA MECHANICAL CODE 2022 CALIFORNIA GREEN BUILDING CODE 2022 CALIFORNIA FIRE CODE 2022 CALIFORNIA ENERGY CODE

LEGAL DESCRIPTION

2022 CALIFORNIA TITLE 24

# PROJECT DATA

**BUILDING DATA** TYPE VB CONSTRUCTION TYPE: OCCUPANCY: STORIES EXISTING 1 STORY 3 STORIES ALLOWED PROPOSED 3 STORIES SPRINKLERS EXISTING YES, EQUIPPED THROUGHOUT WITH PROPOSED NFPA 13R (CBC 903.2.8) **BUILDING HEIGHT** • EXISTING XX' - X" ALLOWABLE 30' - 0" PROPOSED 30' - 0" • HIGHEST OCCUPIED LEVEL 18' - 0" **ELEVATIONS**  MAIN LEVEL FINISH FLOOR XX' - X" ROOF ELEVATION XX' - X" SETBACKS STANDARD ADU FRONT SETBACK 15' - 0" SIDE SETBACK 5' - 0" 4' - 0" STREET SIDE SETBACK 10' - 0" 4' - 0" 4' - 0" REAR SETBACK

REFER TO SECTION "I" OF THE NOTES ON SHEET CG1 & CG2 FOR AN OUTLINE OF THE CAL-GREEN STANDARDS THAT ARE APPLICABLE TO THIS PROJECT. PRIOR TO FINAL INSPECTION, THE LICENSED CONTRACTOR, ARCHITECT, OR ENGINEER RESPONSIBLE OF THE OVERALL CONSTRUCTION MUST PROVIDE TO THE BUILDING DEPARTMENT OFFICIAL WRITTEN VERIFICATION THAT ALL APPLICABLE PROVISIONS 

SPECIAL FLOOD HAZARD AREA

FROM THE GREEN BUILDING STANDARDS CODE HAVE BEEN

IMPLEMENTED AS PART OF THE CONSTRUCTION PER CGC 102.3

### DEFERRED SUBMITTALS

DEFERRED SUBMITTALS SHALL BE PROVIDED FOR THE FOLLOWING BUILDING COMPONENTS / ELEMENTS:

1. RESIDENTIAL FIRE SPRINKLER'S - NFPA 13

2. FIRE ALARM SYSTEM 3. PHOTOVOLTAIC SYSTEM

# **BUILDING AREA SUMMARY**

SEE SHEET TS3


### **CAL-GREEN NOTES**

### SEPARATE PERMITS

1. THE DEMOLITION OF THE EXISTING SHED ON-SITE WILL BE UNDER A SEPARATE PERMIT.

2. THE WORK IN THE PUBLIC RIGHT-OF-WAY WILL BE UNDER A SEPARATE PERMIT

### PROJECT DIRECTORY

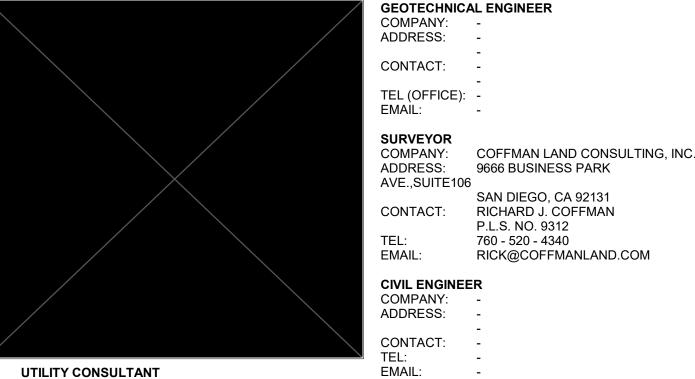

**LANDSCAPE** 

COMPANY:

ADDRESS:

CONTACT:

TEL: EMAIL:

## SHEET INDEX

1 - TITLE SHEETS TS1 COVER SHEET **BUILDING AREA SUMMARY & UNIT** TS3 TABULATION LS1 LIFE SAFETY

1.5 - SURVEYOR 1 TOPOGRAPHIC SURVEY

4 - ARCHITECTURE

A1.1 SITE PLAN A3.1 OVERALL FLOOR PLAN - LEVEL 1 A3.2 OVERALL FLOOR PLAN - LEVEL 2&3 A3.4 ROOF PLAN

A5.1 EXTERIOR ELEVATIONS RICK@COFFMANLAND.COM A5.2 EXTERIOR ELEVATIONS

### **ZONING AND PARCEL INFORMATION (ZAPP)**

COMPANY: -

ADDRESS:

CONTACT:

EMAIL:

TEL (OFFICE): -

PLANNING AREA  COMMUNITY PLAN AREA (CPA)  GENERAL PLAN LAND USE DESIGNATION (GPLU)  COMMUNITY PLAN LAND USE DESIGNATION (CPLU)  COMMUNITY PLAN LAND USE DESNITY RANGE (CPLUDR)  SPECIFIC PLAN AREA (SPA)  BUSINESS IMPROVEMENT DISTRICT (BID)  PRIME INDUSTRIAL LAND (PIL)	GREATER GOLDEN HILL RESIDENTIAL RESIDENTIAL - LOW MEDIUM DENSITY HIGH: 15 DU / ACRE DENSITY LOW: 10 DU / ACRE NO: NONE NO: NONE NO: NONE
PROPOSITION A LANDS (PAL)	NO: NONE
SUSTAINABLE DEVELOPMENT AREAS (SDA)	YES
COMPLETE COMMUNITIES HOUSING SOLUTIONS (CCHS)	NO: NONE
COMPLETE COMMUNITIES MOBILITY CHOICES (CCMC)	YES: MOBILITY ZONE 2
<ul><li>COMMUNITIES OF CONCERN (COC)</li><li>SAN DIEGO PROMISE ZONE (SDPZ)</li></ul>	YES NO
CENTRAL URBANIZED PLANNED DISTRICT (CUPD)	NO
BASE ZONE	
ZONE DESIGNATION	RM-1-1
OVERLAY ZONES	
AIDDODT LAND LICE COMPATIBILITY OVERLAY ZONE (ALLICOZ)	VEC. CAN DIECO INTERNATIO

 AIRPORT LAND USE COMPATIBILITY OVERLAY ZONE (ALUCOZ) YES: SAN DIEGO INTERNATIONAL AIRPORT CLAIREMONT MESA HEIGHT LIMIT OVERLAY ZONE (CMHLOZ)
 NO COASTAL HEIGHT LIMIT OVERLAY ZONE (CHLOZ) COASTAL OVERLAY ZONE (COZ) NO: NONE COASTAL OVERLAY ZONE FIRST PUBLIC ROADWAY (COZFPR) COMMUNITY PLAN IMPLEMENTATION OVERLAY ZONE (CPIOZ) NO: NONE MISSION TRAILS DESIGN DISTRICT (MTDDOZ) NO: NONE

 PARKING IMPACT OVERLAY ZONE (PIOZ) NO: NONE SENSITIVE COASTAL OVERLAY ZONE (SCOZ) NO: NONE TRANSIT AREA OVERLAY ZONE (TAOZ) URBAN VILLAGE OVERLAY ZONE (UVOZ) TRANSPORTATION PARKING STANDARDS TRANSIT PRIORITY AREA (PSTPA) NO TRANSIT PRIORITY AREA (TPA)

 AFFORDABLE HOUSING PARKING DEMAND YES: HIGH ALUCP AIRPORT INFLUENCE AREA (AIA) YES: SAN DIEGO INTERNATIONAL AIRPORT -**REVIEW AREA 1**  ALUCP NOISE CONTOURS (CNEL) YES: SAN DIEGO INTERNATIONAL AIRPORT 65 - 70 CNEL

 ALUCP SAFETY ZONE NO: NONE FAA PART 77 NOTICING AREA SDIA - LINDBERGH FIELD//180 TO 185 FEET ELEVATION ABOVE SEA LEVEL // 16500 TO 17000 FEET HORIZONTAL DISTANCE FROM HISTORIC AND CULTURAL RESOURCES

 CULTURAL SENSITIVITY AREA NO: NONE PALEONTOLOGICAL SENSITIVITY AREA YES: HIGH DESIGNATED HISTORIC DISTRICT NO: NONE DESIGNATED HISTORIC RESOURCE NO: NONE HISTORIC REVIEW EXEMPTION AREA (HREA) ENVIRONMENTALLY SENSITIVE LANDS (ESL) MULTIPLE HABITAT PLANNING AREA (MHPA)

• LA JOLLA SHORES ARCHAEOLOGICAL STUDY AREA (LJSASA)

 SENSITIVE VEGETATION NO: NONE **VERNAL POOLS** NO NON-COASTAL WETLANDS NO COASTAL WETLANDS NO: NONE COASTAL BLUFF NO: NONE COASTAL BEACH NO: NONE STEEP HILLSIDE SPECIAL FLOOD HAZARD AREA ZONE: NO

FLOOD ZONE: X FLOOD ZONE SUBTYPE: AREA OF MINIMAL FLOOD HAZARD SOURCE CITE: 06073C\_FIRM1

NO: NONE

YES

CHOLLAS

PUEBLO SAN DIEGO

 VERY HIGH FIRE HAZARD SEVERITY ZONE (VHFSZ) GEOLOGY AND SOILS ALQUIST-PRIOLO EARTHQUAKE FAULT ZONE NO: NONE EARTHQUAKE FAULT BUFFERS NO: NONE GEOLOGIC HAZARD CATEGORY YES: 52 ELEVATION CONTOUR 5 FEET (1999) MIN: 160 MAX: 165


**HYDROLOGY**  WATERSHED WATERSHED SUBAREA ENVIRONMENTALLY SENSITIVE AREA (ESA) AREAS OF SPECIAL BIOLOGICAL SIGNIFICANCE (ASBS)

BRUSH MANAGEMENT

SLOPES 25% OR GREATER (1999)

SCHOOL DISTRICT ELEMENTARY SCHOOL DISTRICT SAN DIEGO UNIFIED HIGH SCHOOL DISTRICT SEE UNIFIED SCHOOL DISTRICT UNIFIED SCHOOL DISTRICT UNIFIED SAN DIEGO

REV DESCRIPTION DATE

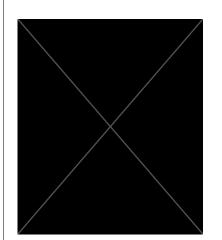

THESE DOCUMENTS ARE INCOMPLETE AND ARE RELEASED FOR INTERIM REVIEW ONLY THESE DOCUMENTS ARE NOT INTENDED F REGULATORY APPROVAL, PERMIT, OR CONSTRUCTION PURPOSES ARCHITECT: THOMAS SEARS
REG. NO.: C-40562

20 AUGUST 2024 SCHEMATIC DESIGN SHEET DISCIPLINE

1 - TITLE SHEETS

COVER SHEET

TS1

LEVEL 3

LEVEL 2

LEVEL 1

301 UNIT A2

302 UNIT B2

303 UNIT C2

201 UNIT A2

202 UNIT B2

203 UNIT C2

101 UNIT A1

102 UNIT B1

103 UNIT C1

ROOM

402 SF

402 SF

442 SF

402 SF

402 SF

442 SF

402 SF

442 SF

UNIT TABULATION

RIGHT TO BUILD

BY RIGHT

BONUS ADU 1

BY RIGHT

BONUS ADU 2

DEED RESTRICTED 4

BONUS ADU 3

DEED RESTRICTED 2

DEED RESTRICTED 1

DEED RESTRICTED 3

BED & BATH

0 BED & 1 BATH

0 BED & 1 BATH

1 BED & 1 BATH

0 BED & 1 BATH

0 BED & 1 BATH

1 BED & 1 BATH

0 BED & 1 BATH

0 BED & 1 BATH

1 BED & 1 BATH

7,025 SF

5,268 SF

1,396 SF

3,789 SF

5,185 SF

5,185 < 5,268 SF

COMPLIANT

0.75

F.A.R. ANALYSIS

SITE ANALYSIS

ALLOWABLE AREA

**EXISTING AREA** 

PROPOSED AREA

COMBINED AREA

DETERMINATION

PROPOSED PROJECT AREA

LOT AREA

F.A.R.

ADA

ADAPTABILITY

CBC 1102A.3.1

CBC 1102A.3.1

CBC 1102A.3.1

CBC 1102A.3.1

CBC 1102A.3.1

CBC 1102A.3.1

ADA ADAPTABLE

ADA ADAPTABLE

ADA ADAPTABLE

AMI DESIGNATION

N/A

N/A

N/A

N/A

MODERATE INCOME

N/A

MODERATE INCOME

MODERATE INCOME

MODERATE INCOME

COMPLIANT

BUILDING AREA

3,789 SF

UNIT B1 (102)

0 BED & 1 BATH

DEED RESTRICTED 1

MODERATE INCOME

402 SF

ADA ADAPTABLE

UNIT C1 (103)

**DEED RESTRICTED 3** 

MODERATE INCOME

442 SF

ADA ADAPTABLE

### CONSTRUCTION OCCUPANCY ALLOWABLE PROPOSED DETERMINATION AREA\*\* AREA TYPE

3,789 SF

7,000

CBC 506.2 ALLOWABLE BUILDING DETERMINATION (SINGLE-OCCUPANCY, MULTISTORY BUILDINGS), THE ALLOWABLE AREA IS INCREASED TO 48,000 SF IN ACCORDANCE WITH EQUATION 5-1:

 $A_a = [A_t + (NS \times I_f)]$ 

TYPE VB R-2

Aa = ALLOWABLE AREA SF At = TABULAR ALLOWABLE AREA FACTOR (NS, S1, S134 OR S13D VALUE, AS

APPLICABLE IN ACCORDANCE WITH TABLE 506.2 NS = TABULAR ALLOWABLE AREA FACTOR IN ACCORDANCE WITH TABLE 506.2 FOR NONSPRINKLERED BUIDLING (REGARDLESS OF WHETHER THE BUILDING IS SPRINKLERED).

I<sub>f</sub> = AREA FACTOR INCREASE DUE TO FRONTAGE (PERCENT) AS CALCULATED IN ACCORDANCE WITH SECTION 506.3

> $A_t = 7,000 SF$  $A_a = [A_t + (NS \times I_f)]$  $A_a = [7,000 \text{ SF} + (7,000 \text{ SF} \times 0)]$ NS = 7,000 SF  $A_a = 7,000 SF$  $I_f = 0$ ALLOWABLE AREA = 7,000 SF

1. BUILDING AREA EXCLUDES USABLE OPEN SPACE (THE NUMBER USED IN

THE F.A.R. CALCULATIONS IS DIFFERENT) 2. TOTAL FLOOR AREA INCLUDES USABLE ÓPEN (THIS NUMBER IS USED IN


= 3,789 SF COMPLIANT


PROPOSED AREA

ALLOWABLE AREA CALCULATIONS ONLY) 3. ALLOWABLE AREA PER FLOOR IN ACCORDANCE WITH S13R CLASSIFICATION PER CBC SECTION 506 AND TABLE 506.2

# 92102 DIEG( $\Box$ 316



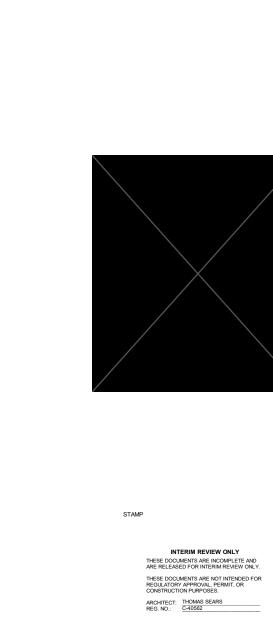

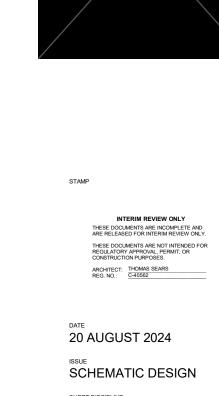


SHEET DISCIPLINE

1 - TITLE SHEETS BUILDING AREA SUMMARY & UNIT TABULATION


TS3

BAS - LEVEL 2 1/8" = 1'-0"

UNIT A2 (301) UNIT B2 (302) 0 BED & 1 BATH 0 BED & 1 BATH BY RIGHT BONUS ADU 1 N/A N/A 402 SF 402 SF CBC 1102A.3.1 CBC 1102A.3.1 UNIT C2 (303) 1 BED & 1 BATH BY RIGHT N/A 442 SF CBC 1102A.3.1

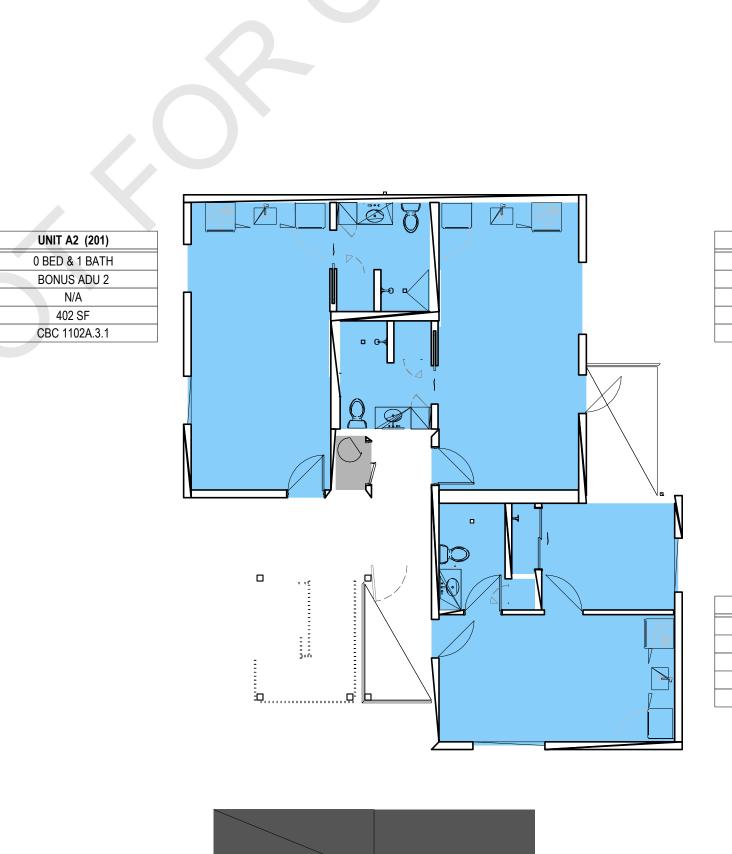



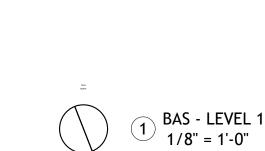

UNIT A1 (101)

0 BED & 1 BATH


DEED RESTRICTED 2

MODERATE INCOME


402 SF

ADA ADAPTABLE

DOORS  1010.1.1 SIZE OF DOORS THE REQUIRED CAPACITY OF EACH DOOR OPENING SHALL BE SHEROLINE FOR THE OCCUPANT LOAD THEREOF AND SHALL PROVIDE A MINIMUM CLEAR OPENING WIDTH OF 32 INCHES. THE CLEAR OPENING WIDTH OF DOORWAYS WITH SWINGING DOORS SHALL BE MEASURED BETWEEN THE FACE OF THE DOOR AND THE STOP, WITH THE DOOR OPEN 90 DEGREES. WHERE THIS SECTION REQUIRES A MINIMUM CLEAR OPENING WIDTH OF 32 INCHES AND A DOOR OPENING INCLUDES TWO DOOR LEAVES WITHOUT A MULLION, ONE LEAF SHALL PROVIDE A MINIMUM CLEAR OPENING WIDTH OF 32 INCHES. THE MINIMUM CLEAR OPENING HEIGHT OF DOORS SHALL BE NOT LESS THAN 80 INCHES.	R-2 20 NP NP 125a R-2.1 10 NP NP 75a R-2.2 20 NP NP 125a R-3e, R-3.1e 20 NP NP 125a, g R-4e 20 NP NP 125a, g Sf 29 100 75 100a STAIR U 49 100 75 75a  TOTAL	2 402 SF RESIDENTIAL 200 3 2 402 SF RESIDENTIAL 200 3 2 64 SF RESIDENTIAL BALCONY 200 1 2 442 SF RESIDENTIAL 200 3 17 SF MECHANICAL EQUIPMENT 300 1 11  STAIR(S)  STAIR ANALYSIS - LEVEL 3  AIR DOOR STAIR CAPACITY REQUIRED PROVIDED ASSIGNED	UNIT A2	B1       402 SF RESIDENTIAL       200       3         B1b       65 SF RESIDENTIAL BALCONY       200       1         C1       442 SF RESIDENTIAL       200       3	EGRESS BALCONY  EXTERIOR STAIR  EXIT ACCESS  EXIT ENCLOSURE  ELEVATOR  ACCESSORY STORAGE AREAS OCCUPANT LOAD FACTOR = 7 NET  ASSEMBLY - CONCENTRATED OCCUPANT LOAD FACTOR = 15 NET  MECHANICAL EQUIPMENT ROOM OCCUPANT LOAD FACTOR = 300 GROSS	EGRESS AREA TAG AREA NAME (ROOM #) OCCUPANT LOAD  EXIT TAG EXIT NAME ASSIGNED OCCUPANTS OCCUPANT CAPACITY  STAIR TAG STAIR # ASSIGNED OCCUPANTS DOOR WIDTH STAIR WIDTH PROVIDED PROVIDED (INCHES) (INCHES)  # OCCUPANT LOAD SYMBOL INCLUDES ACCUMLATING OCCUPANT LOADS.	
		x					

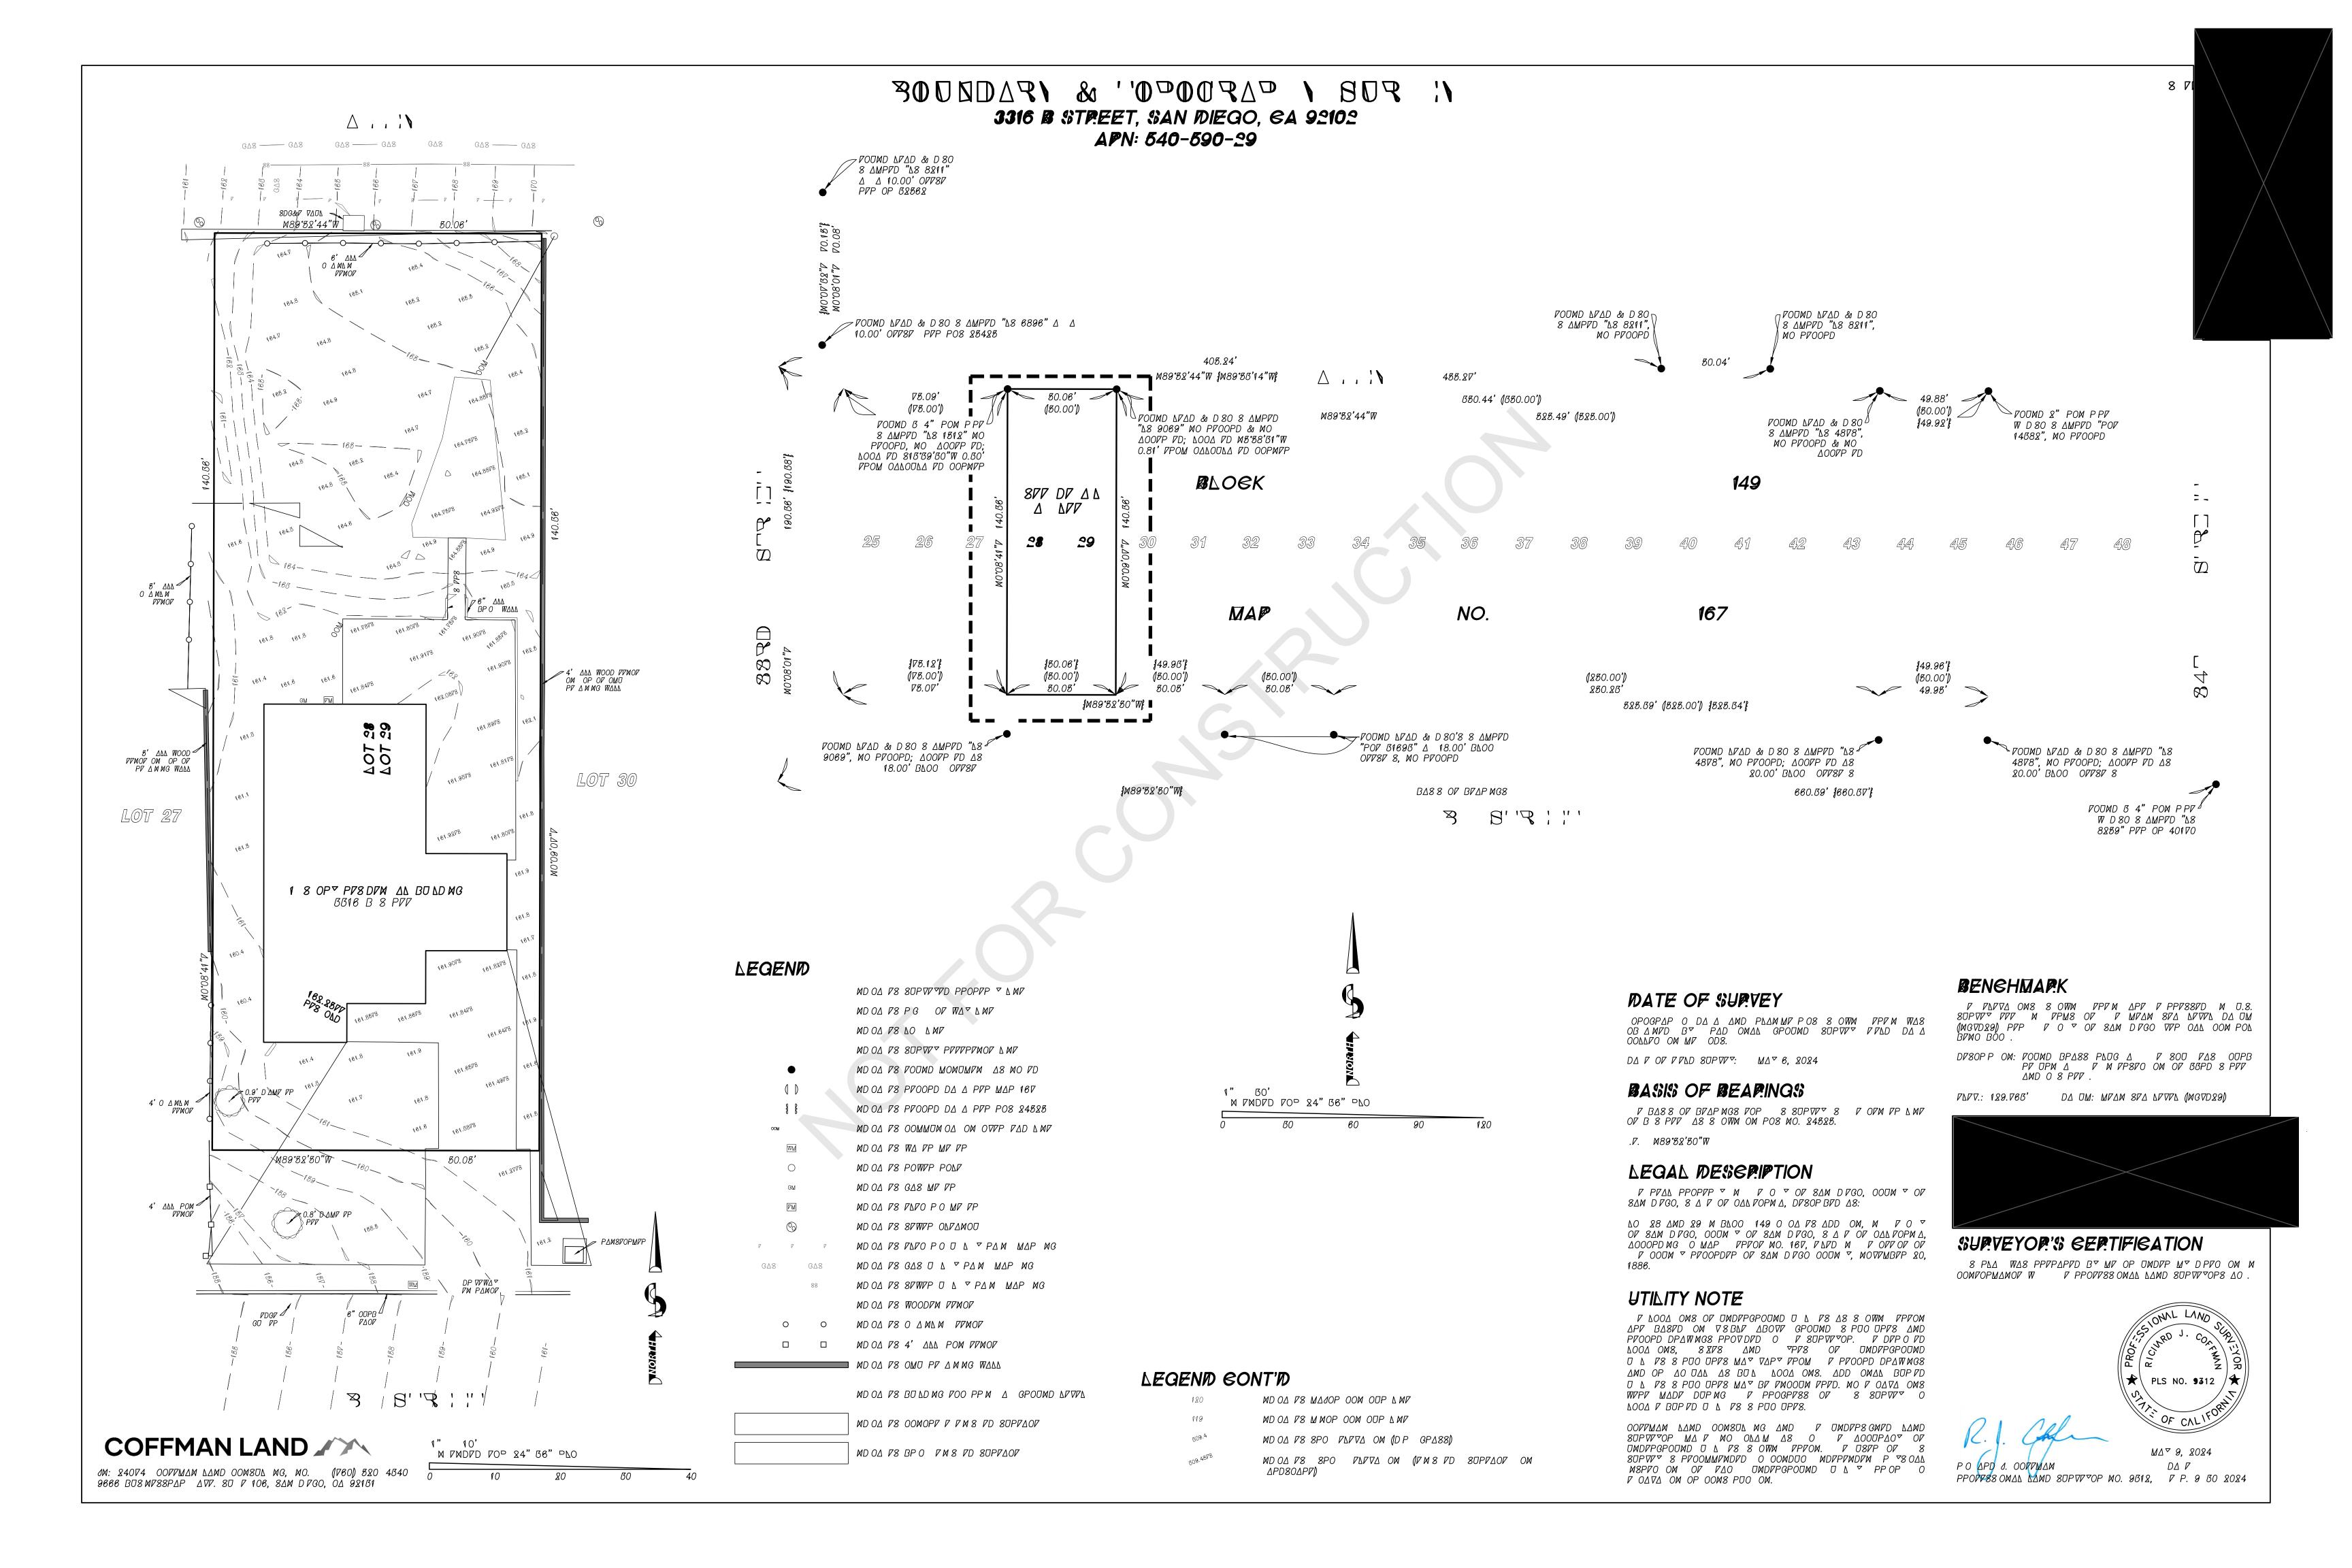

(E) GAS SERVICE (E) SEWER MAIN (E) ELETRIC SERVICE

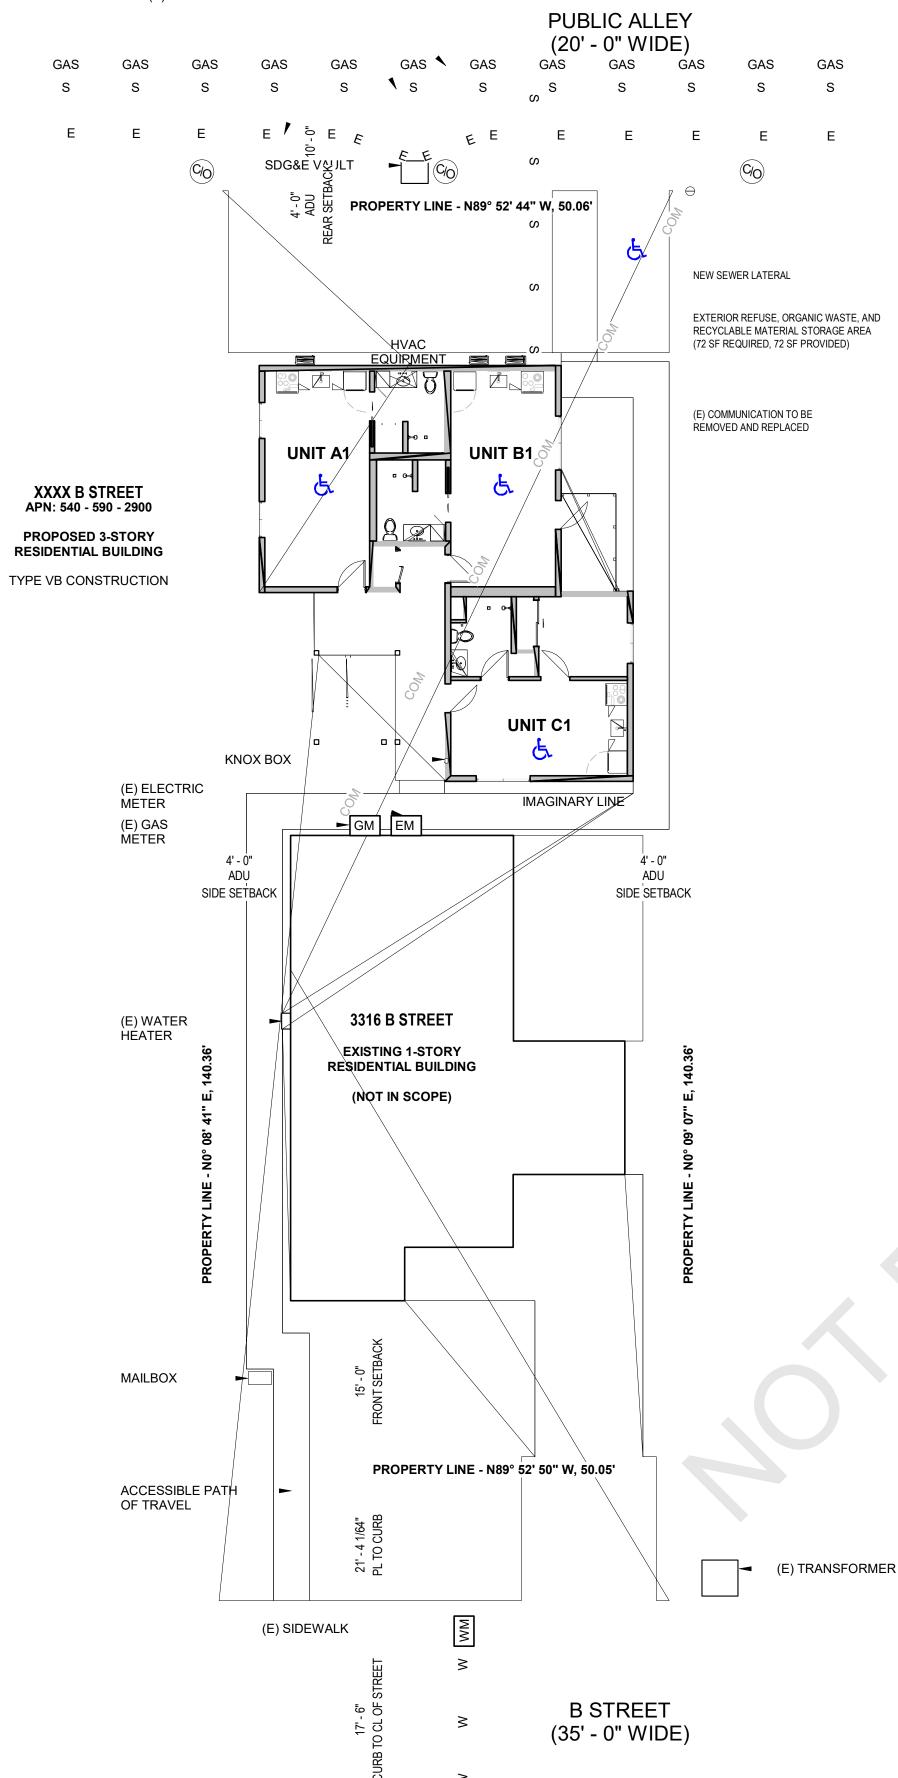

1 SITE PLAN 3/32" = 1'-0"



### SITE PLAN NOTES

UTILITY NOTES

START OF DEMOLITION.

CREDITED TO THE OWNER.

- 1. SEE LANDSCAPE DWGS FOR PLANTING PLANTS, IRRIGATION PLANS AND DETAILS, SITE FUNISHINGS AND PAVERS.
- 2. SEE CIVIL DWGS FOR FINE GRADING & DRAINAGE, WATER QUALITY BASINS, DRIVE SURFACE DETAILING.
- 3. ON GRADE PATIOS SHALL SLOPE AWAY FROM BUILDING @ MIN 1/8":12 TYP.
- PER CBC SECTION 1109A.4 ASSIGNED ACCESSIBLE PARKING SPACES: WHEN ASSIGNED PARKING SPACES ARE PROVIDED FOR A RESIDENT OR A GROUP OF RESIDENTS, AT LEAST 2 PERCENT OF THE ASSIGNED PARKING SPACES SERVING COVERED MULTIFAMILY DWELLING UNITS SHALL BE ACCESSIBLE IN EACH TYPE OF PARKING FACILITY. AT LEAST ONE SPACE OF EACH TYPE OF PARKING FACILITY SHALL BE MADE ACCESSIBLE EVEN IF THE TOTAL NUMBER EXCEEDS TWO PERCENT. WHEN ASSIGNED PARKING IS PROVIDED, SIGNAGE AS REQUIRED BY SECTION 1109A.8.8 SHALL NOT BE REQUIRED. STRIPED LOADING ZONE ONLY.
- SHOULD ANY ARCHEOLOGICAL (CULTURAL) RESOURCES OR HUMAN REMAINS BE DISCOVERED DURING CONSTRUCTION-PHASE GROUND-DISTURBING ACTIVITIES, ALL WORK IN THE IMMEDIATE VICINITY MUST STOP AND THE CONTRACTOR SHALL NOTIFY THE CITY OF SAN DIEGO IMMEDIATELY.
- A. A QUALIFIED PROFESSIONAL SHALL BE RETAINED TO EVALUATE THE FINDS AND RECOMMEND APPROPRIATE ACTION.

1. CONTRACTOR TO CONFIRM THE SHUT-OFF AND

REMOVAL (OR CAPPING) OF UTILITIES W/ ALL

2. ALL COPPER PLUMBING LINES REMOVED DURING

REIMBURSEMENT FOR THIS MATERIAL SHALL BE

DEMOLITION SHALL BE RECYLED. ANY

3. ALL ELECTRICAL TO BE REMOVED AND

4. ALL EXISTING DUCTWORK AND FORCED AIR

TEST DUCT LINING FOR ASBESTOS AND

FURNACE TO BE REMOVED. CONTRACTOR TO

PERFORM ABATEMENT PER EPA STANDARDS IF

REPLACED WITH NEW WIRING.

TEST RESULTS ARE POSITIVE.

APPLICABLE UTILITY COMPANIES PRIOR TO THE

B. FOR HUMAN REMAINS, THE CONTRACTOR SHALL NOTIFY THE COUNTY CORONER.

THE ENVIRONMENT.


INSPECTIONS.

CONSTRUCTION, AND MEANS OF PROTECTION TO BE VISIBLE DURING

ALL EXISTING DRAINAGE INLETS TO BE PROTECTED DURING


- C. FOR HUMAN REMAINS DETERMINED TO BE OF NATIVE AMERICAN ORIGIN, THE PROCEDURES OUTLINED IN CEQA SECTION 15064.5 (D) AND (E) SHALL BE FOLLOWED. THE CONTRACTOR SHALL ENSURE, TO THE SATISFACTION OF THE CITY AND THE NATIVE AMERICAN HERITAGE FOUNDATION, IF APPLICABLE, THAT APPROPRIATE MEASURES ARE UNDERTAKEN PRIOR TO RESUMING ANY PROJECT ACTIVITIES THAT MAY AFFECT SUCH RESOURCES.
- 6. ALL REQUIRED FIRE LANES, FIRE LANE MARKINGS AND SIGNAGE SHALL BE PROVIDED, INSTALLED AND APPROVED BY THE FIRE CODE OFFICIAL AHD A FIRE LANE EASEMENT SHALL BE RECORDED.
- PRIOR TO OCCUPANCY AN AUTOMATIC FIRE SPRINKLER SYSTEM COMPLYING WITH NFPA 13 SHALL BE PROVIDED, THREE SETS OF PLANS, SPECIFICATIONS AND HYDRAULICS SHALL BE SUBMITTED FOR REVIEW, APPROVAL AND PERMITS PRIOR TO COMMENCING WORK.
- 8. PRIOR .TO OCCUPANCY AN AUTOMATIC FIRE ALARM SYSTEM COMPLYING WITH NFPA 72 AND THE CALIFORNIA FIRE CODE SHALL BE PROVIDED. THREE SETS OF PLANS, SPECIFICATIONS AND HYDRAULICS SHALL BE SUBMITTED FOR REVIEW, APPROVAL AND PERMITS PRIOR TO COMMENCING WORK.
- 9. A CLASS I STANDPIPE SYSTEM IS REQUIRED. A STATE OF CALIFORNIA LICENSED C-16 CONTRACTOR SHALL SUBMIT THREE (3) SETS OF PLANS, SPECIFICATION, AND HYDRAULIC CALCULATIONS TO THE FIRE DEPARTMENT FOR REVIEW, APPROVAL AND PERMITS.
- 10. PERMANENT MULTI-FAMILY THREE DIMENSIONAL STREET NUMBERS, MINIMUM OF TWELVE INCHES IN HEIGHT, INSTALLED ON CONTRASTING BACKGROUNDS, AND SHALL BE PROVIDED ON THE ADDRESS SIDE OF EACH BUILDING AS DIRECTED BY THE FIRE CODE OFFICIAL.

- 11. KNOX BOXES: INSTALL KNOX KEY BOXES: TWO STANDARD SIDE-HINGED KNOX BOXES ARE REQUIRED IN LOCATION DETERMINED BY FIRE DEPT. ONE KNOX BOX SHALL BE MOUNTED NEAR FIRE COMMAND ROOM. MASTER KEYS TO ALL UTILITY CLOSETS, FIRE COMMAND ROOM, RISER ROOMS AND OTHER COMMON AREAS ARE REQUIRED BY FIRE DEPARTMENT. ALSO, PROVIDE A KNOX SERIES 1400 - ELEVATOR BOX IS REQUIRED TO BE INSTALLED ON FIRST FLOOR LEVEL NEAR EACH ELEVATOR. KEYS IN ELEVATOR BOX SHALL BE THE FOLLOWING: PROVIDE 4 ELEVATOR KEYS AND TWO ELEVATOR DOOR DROP KEYS. ALSO, PROVIDE KEY TO ACCESS ELEVATOR CONTROL ROOM. MAX MOUNTING HEIGHT IS 60-66 INCHES TO TOP OF ANY KNOX BOX.
- 12. ALL PRIVATE ROADS, ACCESS DRIVES AND ON SITE STREETS SHALL BE PROPERLY MARKED WITH SIGNS THAT READ 'NO PARKING- FIRE LANE. SIGNS SHALL COMPLY WITH 2022 CA. VEHICLE CODE.

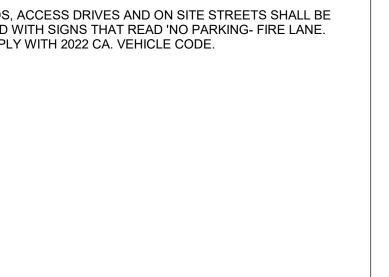

ΤY	PICAL EROSION CONTROL NOTES:	SITE PLAN	LEGEND		PROJECT INFO	RMATION	
1. 2.	THE CONTRACTOR SHALL BE RESPONSIBLE FOR CLEANUP OF ALL SILT AND MUD ON ADJACENT STREETS DUE TO THE CONSTRUCTION VEHICLES OR ANY OTHER CONSTRUCTION ACTIVITY, AT THE END OF EACH WORKDAY, OR AFTER A STORM EVENT THAT CAUSES A BREECH IN INSTALLED CONSTRUCTION BMP'S, WHICH MAY COMPROMISE STORM WATER QUALITY WITHIN ANY STREET. A STABILIZED CONSTRUCTION EXIT MAY BE REQUIRED TO PREVENT CONSTRUCTION VEHICLES OR EQUIPMENT FROM TRACKING MUD OR SILT INTO THE STREET.  A II STOCKPILES OF SOIL AND OR BUILDING MATERIALS THAT ARE INTENDED TO BE LEFT FOR A PERIOD GREATER THAN SEVEN CALENDAR DAYS ARE TO BE COVERED. ALL REMOVABLE BMP DEVICES SHALL BE IN	FDC KB P/A		ROPERTY LINE  CC. PATH OF TRAVEL  INECTION	PROJECT LOCA 3316 B STREET SAN DIEGO, CA PARCEL NUMBI 540 - 590 - 2900 LOT SIZE: 7,025 SF (0.16 A ZONING: RM-1-1	A 92102 ER:	
3.	PLACE AT THE END OF EACH WORKING DAY WHEN THE FIVE-DAY RAIN PROBABILITY FORECAST EXCEEDS 40%.  A CONCRETE WASHOUT SHALL BE PROVIDED ON ALL PROJECTS, WHICH PROPOSE THE CONSTRUCTION OF ANY CONCRETE IMPROVEMENTS THAT				FRONT	STANDARD 15' - 0" 5' - 0"	ADU 4' - 0"
	ARE TO BE POURED IN PLACE ON SITE.						4' - 0" 4' - 0"
4.	THE CONTRACTOR SHALL RESTORE ALL EROSION/SEDIMENT CONTROL DEVICES TO WORKING ORDER AFTER EACH RUN-OFF PRODUCING RAINFALL OR AFTER ANY MATERIAL BREACHES ITS EFFECTIVENESS.						
5.	ALL SLOPES THAT ARE CREATED OR DISTURBED BY CONSTRUCTION ACTIVITY MUST BE PROTECTED AGAINST EROSION AND SEDIMENT TRANSPORT AT ALL TIMES.						
3.	THE STORAGE OF ALL CONSTRUCTION MATERIAL AND EQUIPMENT MUST BE PROTECTED AGAINST ANY POTENTIAL RELEASE OF POLLUTANTS INTO						

REV DESCRIPTION DATE

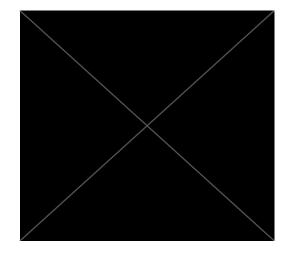

THESE DOCUMENTS ARE INCOMPLETE AND ARE RELEASED FOR INTERIM REVIEW ONLY THESE DOCUMENTS ARE NOT INTENDED F REGULATORY APPROVAL, PERMIT, OR CONSTRUCTION PURPOSES. ARCHITECT: THOMAS SEARS
REG. NO.: C-40562

20 AUGUST 2024 SCHEMATIC DESIGN SHEET DISCIPLINE
4 - ARCHITECTURE SHEET NAME SITE PLAN




### **GUIDE**

- 1. REFER TO A2.1x FOR ASSEMBLY INFORMATION.
- 2. REFER TO A5.X FOR EXTERIOR ELEVATIONS.
- 3. REFER TO A7.X FOR FOR ENLARGED UNIT PLANS & REFLECTED CEILING PLANS / ENLARGED KITCHEN DRAWINGS / BATHROOM DRAWINGS, AND ADDITIONAL NOTES.
- 4. REFER TO A8.X FOR STAIR & HANDRAIL DRAWINGS.
- 5. REFER TO A9.1 FOR DOOR SCHEDULE.
- 6. REFER TO A9.5 FOR WINDOW SCHEDULE

### FLOOR PLAN NOTES

- 1. THE PROJECT SHALL CONFORM TO ALL FIRE DEPARTMENT REQUIREMENTS AS OUTLINED
- 2. THE PROJECT SHALL CONFORM TO ALL CAL-GREEN REQUIREMENTS AS OUTLINED ON SHEETS CG.1 & CG.2.
- 3. ALL EXTERIOR AND INTERIOR FINISH MATERIALS SHALL BE INSTALLED PER MANUFACTURER RECOMMENDATIONS.
- 4. ALL DIMENSIONS TO FACE OF STUD UNLESS NOTED OTHERWISE.
- 5. GRID LINES INDICATE THE EXTERIOR FACE OF STRUCTURAL WALLS, UNLESS NOTED
- 6. WRITTEN DIMENSIONS TO PREVAIL OVER SCALING OF DRAWINGS. CONTRACTOR TO VERIFY ALL DIMENSIONS PRIOR TO CONSTRUCTION AND NOTIFY ARCHITECT OF ANY
- 7. ALL WORK SHALL BE COMPLETED IN ACCORDANCE WITH LOCAL, STATE AND FEDERAL CODES, LAWS AND THE 2022 EDITION OF THE CBC.
- 8. THESE DRAWINGS DO NOT PROVIDE ALL PROVISIONS FOR WATERPROOFING. THE CONTRACTOR IS TO BE CONSIDERED AN EXPERT AND SHALL PROVIDE ALL PROVISIONS NECESSARY TO WATERPROOF THE STRUCTURE.
- 9. ANY PENETRATIONS THROUGH RATED ASSEMBLIES SHALL BE PROTECTED PER THE PROVISIONS OF CBC SECT. 714
- 10. THE WALLS AND OPENINGS BETWEEN THE GARAGE AND ADJACENT OCCUPIED SPACES SHALL BE SEALED.
- 11. INSULATION MATERIAL SHALL MEET THE CALIFORNIA QUALITY STANDARD PER SECTION 118 ENERGY EFFICIENCY STANDARDS
- 12. BUILDING ASSEMBLIES AND COMPONENTS WITH STC VALUES DETERMINED IN ACCORDANCE WITH ASTM E90 AND ASTM E413 SHALL BE EMPLOYED.
- 13. PORTABLE FIRE EXTINGUISHERS WILL BE INSTALLED IN THE BUILDING IN ACCORDANCE WITH CBC SECTION 906.
- 14. IN BUILDINGS REQUIRED TO HAVE STANDPIPES, NOT LESS THAN ONE STANDPIPE SHALL BE PROVIDED FOR USE DURING CONSTRUCTION. STANDPIPES SHALL BE REVIEWED AND APPROVED PRIOR TO INSTALLATION.
- 15. CLASS I STANDPIPES MAY BE USED, BECAUSE THE BUILDING IS EQUIPPED THROUGHOUT WITH AN AUTOMATIC SPRINKLER SYSTEM. SECTION 905.
- 16. FIRE PROTECTION EQUIPMENT SHALL BE IDENTIFIED IN AN APPROVED MANNER. ROOMS CONTAINING CONTROLS FOR AIR-CONDITIONING SYSTEMS, SPRINKLER RISERS, AND VALVES OR OTHER FIRE DETECTION, SUPPRESSION OR CONTROL ELEMENTS SHALL BE IDENTIFIED FOR THE USE OF THE FIRE DEPARTMENT. APPROVED SIGNS REQUIRED TO IDENTIFY FIRE PROTECTION EQUIPMENT AND EQUIPMENT LOCATION SHALL BE CONSTRUCTED OF DURABLE MATERIALS, PERMANENTLY INSTALLED AND READILY VISIBLE, IN ACCORDANCE WITH SECTION 914.2.
- 17. WHERE COLUMNS ARE REQUIRED TO BE FIRE-RESISTANCE RATED BY ANY PROVISIONS OF THE CODE, THE ENTIRE COLUMN SHALL BE PROVIDED INDIVIDUAL ENCASEMENT PROTECTION ON ALL SIDES FOR THE FULL COLUMN LENGTH. SECTION 704.2
- 18. AT HAZARDOUS VEHICULAR AREAS, DETECTABLE WARNING SURFACES SHALL BE YELLOW CONFORMING TO FS 33538 OF FEDERAL STANDARD 595C. [CBC 1112A.9;11 B-705.1.1.3
- 19. ONLY APPROVED DSA-AC DETECTABLE WARNING PRODUCTS AND DIRECTIONAL SURFACES SHALL BE INSTALLED AS PROVIDED IN THE CALIFORNIA CODE OF REGULATIONS (CCR), TITLE 24, PART 1, CHAPTER 5, ARTICLE 2, 3 AND 4." (CBC, SEC. 1112A.9; 11B-705.3)

## WALL LEGEND

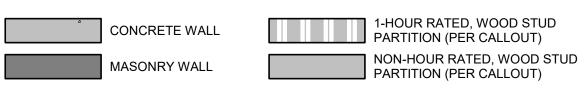


### PARTITION NOTES

- 1. ALL FIRE RATED ASSEMBLIES TO CONFORM TO THE REQUIREMENTS OF THE ENFORCEMENT AGENCY AND FIRE RESISTANCE DESIGN NUMBER NOTED.
- 2. WALL ASSEMBLIES ARE NOTED ON THE OVERALL FLOOR PLANS (A2 SERIES) AND ENLARGED UNIT PLANS (A6 SERIES).
- 3. FLOOR/CEILING AND ROOF ASSEMBLIES ARE NOTED ON WALL SECTIONS.
- 4. PROVIDE ACOUSTICAL INSULATION AT ALL RECESSED DEVICES (OUTLETS, SWITCHES, ETC.) IN PARTY WALLS SEPARATING INDIVIDUAL RESIDENTIAL UNITS AND AT FLOOR/CEILING ASSEMBLIES.
- 5. AT PARTY WALLS AND THE INTERIOR FACE OF EXT. WALLS, ALL PENETRATIONS, JOINTS, PERIMETER GAPS, AND INTERSECTIONS WITH CEILINGS, FLOORS AND OTHER WALLS SHALL BE SEALED WITH ACOUSTICAL SEALANT EVEN IF THEY WILL LATER BE TAPED AND FINISHED WITH DRYWALL COMPOUND. JOINTS BETWEEN DRYWALL SHEETS NEED NOT BE CAULKED. STAGGER JOINTS BETWEEN THE BASE LAYER AND FACE LAYER AS INDICATED IN PARTITION DETAILS.
- 6. THE FINISH MATERIAL OF WALLS WITH AND WITHOUT PLYWOOD SHEATHING AND THAT ARE ADJACENT TO AND IN THE SAME PLANE AS EACH OTHER SHALL BE CONTINUOUS AND UNINTERRUPTED ACROSS THE ENTIRE SURFACE OF BOTH WALLS. APPLY PLYWOOD FURRING WITH THE SAME THICKNESS AS THE PLYWOOD SHEATHING TO THE STUD FRAMING OF THE WALL WITHOUT PLYWOOD SHEATHING. THE FURRING ON THE WALL WITHOUT PLYWOOD SHEATHING SHALL BE CONTINUOUS UP TO WHERE THE WALL ENDS OR CHANGES DIRECTION.
- 7. PROVIDE THERMAL INSULATION AS NOTED IN ASSEMBLY DETAILS ON SHEETS A9.0 & A9.1 AND PER THE WALL SCHEDULE ON THIS SHEET.

### FINISH NOTES

- 1. INTERIOR DRYWALL FINISHES SHALL BE TAPED, COATED AND SANDED TO A 'LEVEL 4' SMOOTH FINISH. PROVIDE SQUARE CORNER BEADS AT ALL CORNERS AND FIRE CAULKING AROUND ALL PENETRATIONS THROUGH RATED FLOOR/CEILING AND WALL ASSEMBLIES.
- 2. INTERIOR PAINT SHALL REQUIRE TWO COATS OF SPARTAWALL LOW VOC INTERIOR ACRYLIC PAINT OVER PRIMER. THERE WILL BE A PRIMARY COLOR FOR THE WALLS, AN ACCENT COLOR FOR A LIMITED NUMBER OF WALLS AND CEILING COLOR (3 COLORS TOTAL). FLAT PAINT TO BE USED EVERYWHERE EXCEPT KITCHENS, BATHROOMS, DOORS, AND TRIM. USE LOW SHEEN IN AREAS SUSCEPTIBLE TO MOISTURE AND SEMI-GLOSS FOR DOORS AND MOLDING TRIM.

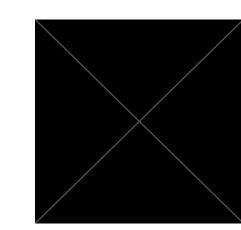

REV DESCRIPTION DATE


THESE DOCUMENTS ARE INCOMPLETE AND ARE RELEASED FOR INTERIM REVIEW ONLY. ARCHITECT: THOMAS SEARS
REG. NO.: C-40562


20 AUGUST 2024 SCHEMATIC DESIGN

4 - ARCHITECTURE

OVERALL FLOOR PLAN -

LEVEL 1

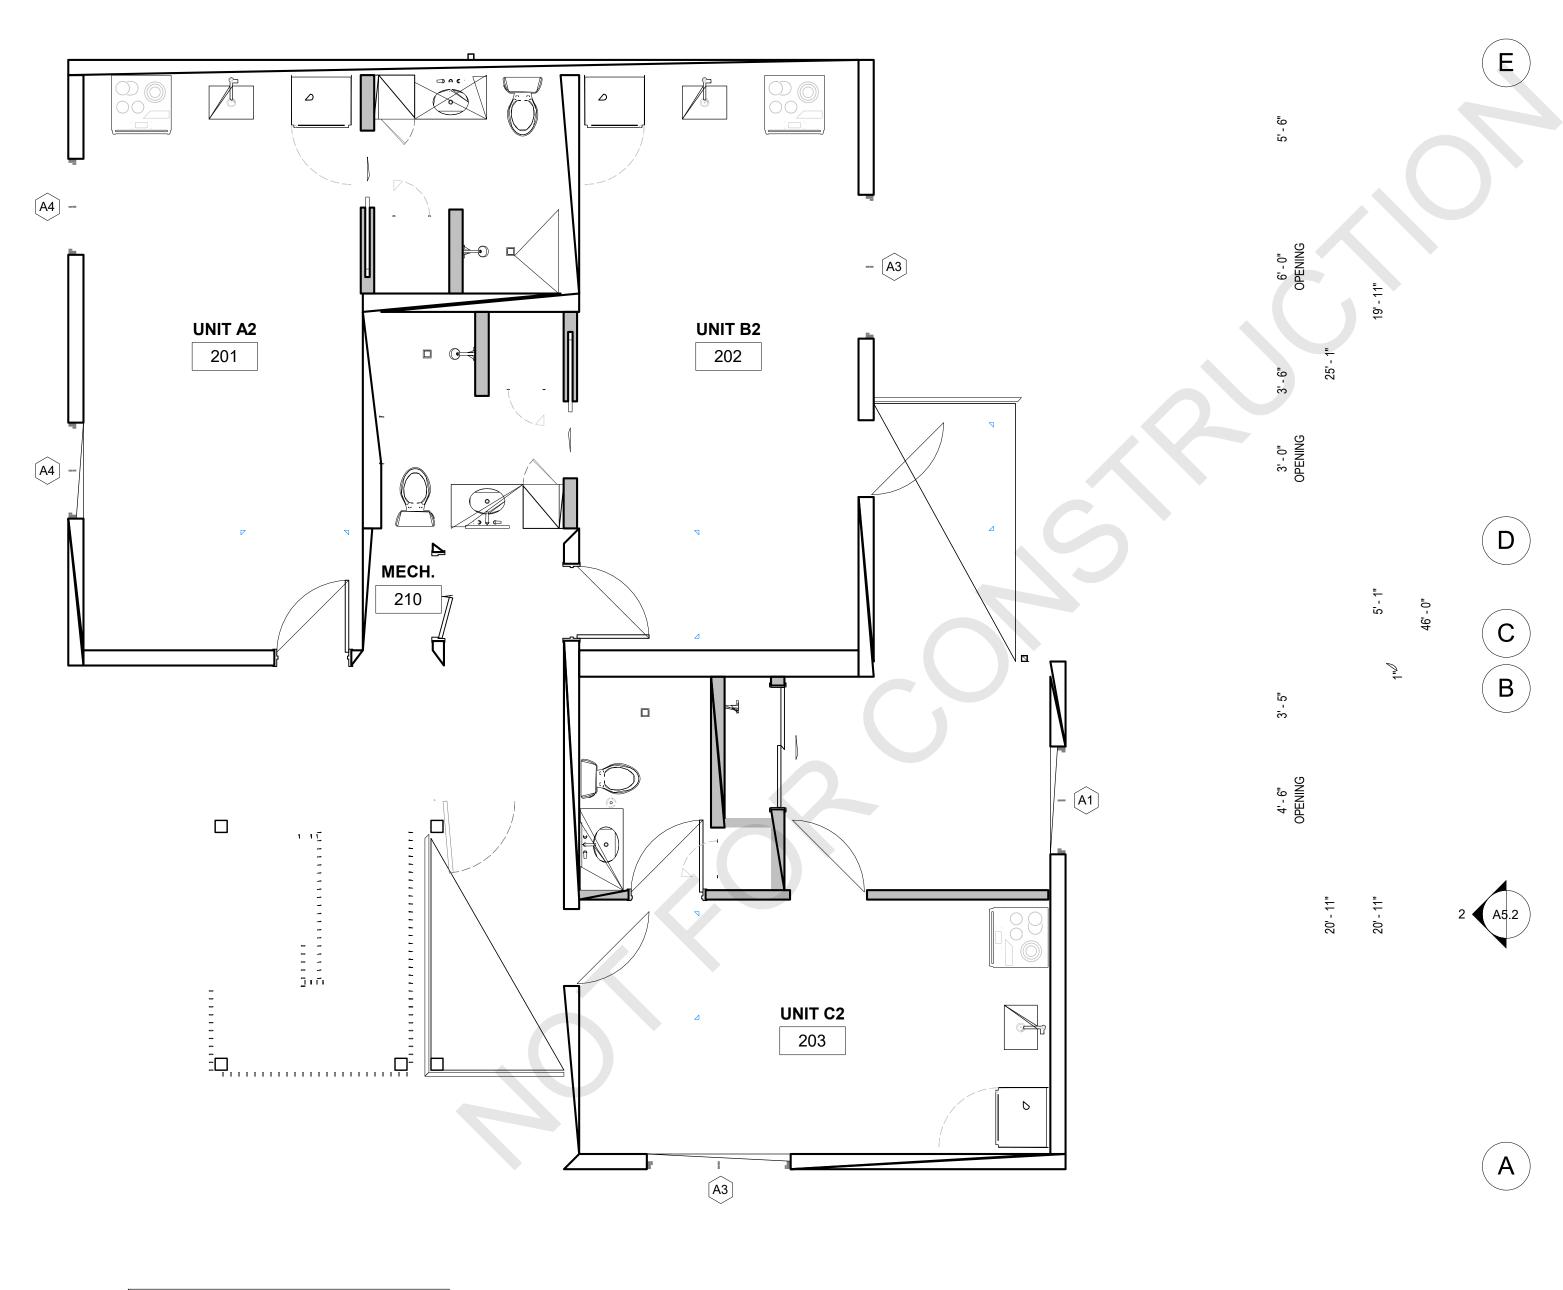

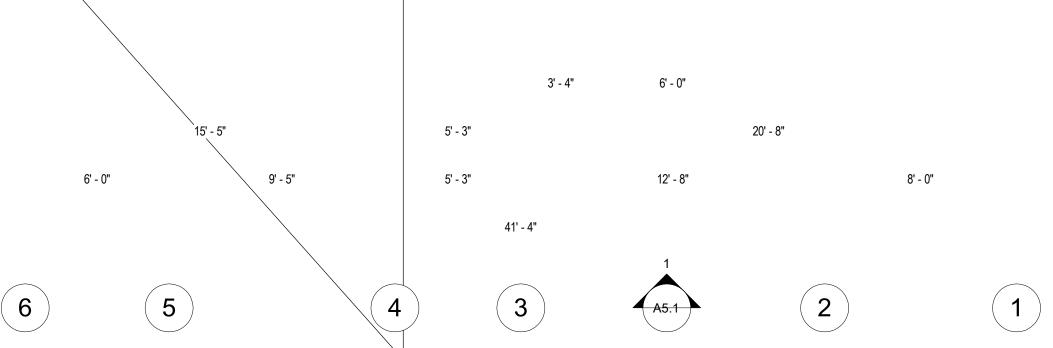

OVERALL FLOOR PLAN - LEVEL 2&3 1/4" = 1'-0"

### GUIDE


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- 6. THE FINISH MATERIAL OF WALLS WITH AND WITHOUT PLYWOOD SHEATHING AND THAT ARE ADJACENT TO AND IN THE SAME PLANE AS EACH OTHER SHALL BE CONTINUOUS AND UNINTERRUPTED ACROSS THE ENTIRE SURFACE OF BOTH WALLS. APPLY PLYWOOD FURRING WITH THE SAME THICKNESS AS THE PLYWOOD SHEATHING TO THE STUD FRAMING OF THE WALL WITHOUT PLYWOOD SHEATHING. THE FURRING ON THE WALL WITHOUT PLYWOOD SHEATHING SHALL BE CONTINUOUS UP TO WHERE THE WALL ENDS OR CHANGES DIRECTION.
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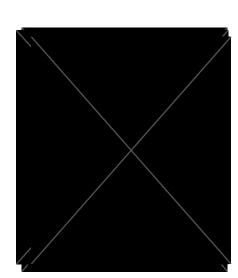
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3316

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ARCHITECT: THOMAS SEARS
REG. NO: C-4056S2

20 AUGUST 2024

SCHEMATIC DESIGN

SHEET DISCIPLINE

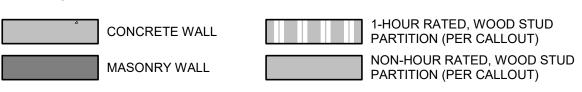4 - ARCHITECTURE

OVERALL FLOOR PLAN -LEVEL 2&3

A3 2

- 1. UL CLASS A FIRE RESISTANCE RATING AND CLASS 90 WIND RESISTANCE, ICC ESR-1184
- 2. UL CERTIFIED TO MEET ASTM D6878
- 3. SHALL COMPLY WITH CALIFORNIA BUILDING STANDARDS CODE REQUIREMENTS FOR "COOL ROOF" SYSTEM INCLUDING THREE YEAR AGED SOLAR REFLECTANCE VALUE REQUIREMENTS. PROVIDE WITH CRRC LABEL.
- 4. SHALL MEET ENERGY STAR REQUIREMENTS FOR BOTH SOLAR REFLECTANCE AND THERMAL

### ROOF PLAN NOTES

- 1. SUBSTITUTE MATERIALS ARE NOT TO BE USED UNLESS APPROVED IN WRITING BY THE
- 2. ALL HORIZONTAL SURFACES (ROOFS, DECKS, PARAPET CAPS, ETC.) SHALL SLOPE AT LEAST 3/8" PER FT. U.N.O.
- 3. UNLESS NOTED OTHERWISE ALL ROOFING SURFACES SHALL SLOPE AT 3/8": 12". FOAM CRICKETS SHALL SLOPE AT MINIMUM 1/4" : 12" TYPICAL. ROOF CRICKETS SHALL BE TAPERED FOAM CRICKETS PER SPECS INSTALLED PER MANUFACTURER RECOMMENDATIONS.
- 4. ALL WEATHERPROOFING MATERIALS SHALL BE LAPPED IN THE DIRECTION OF WATER
- 5. SEALANT SHOULD NOT BE CONSIDERED A MEANS OF WATERPROOFING PROTECTION.
- 6. THESE DRAWINGS DO NOT PROVIDE ALL PROVISIONS FOR WATERPROOFING. THE CONTRACTOR IS CONSIDERED TO BE AN EXPERT AND SHALL PROVIDE ALL PROVISIONS NECESSARY TO WATERPROOF THE STRUCTURE.
- 7. ALL COMPLETED WORK SHALL BE PROTECTED FROM DAMAGE UNTIL COMPLETION OF THE
- 8. REFER TO MECHANICAL DRAWINGS FOR LOCATION OF PIPE PENETRATIONS THROUGH
- THE ROOF. 9. THE DISCHARGE POINT FOR EXHAUST AIR SHALL BE AT LEAST 3'-0" FROM ANY OPENING
- WHICH ALLOWS AIR ENTRY INTO OCCUPIED PORTIONS OF THE BUILDING. 10. MECHANICAL EQUIPMENT REQUIRING MAINTENANCE SHALL BE LOCATED 10'-0" MIN. FROM
- 11. VERIFY ALL ROOF OPENINGS FOR MECHANICAL UNITS, DUCT SHAFTS, OR VENTILATION SHAFTS W/ MANUFACTURER OR INSTALLER PRIOR TO FRAMING PENETRATIONS.
- 12. PROVIDE ROOF JACKS AT EACH UNIT FOR ALL ELECTRICAL AND GAS PIPING PENETRATIONS. VERIFY SERVICE CONNECTION LOCATION ON ALL UNITS AND FLASH PER
- 13. PROVIDE ROOF JACKS AT EACH ROOFTOP CONDENSER FOR ELECTRICAL AND REFRIGERANT PIPING PENETRATIONS. VERIFY LOCATION WITH MECH..
- 14. PROVIDE INSULATION PER SPECIFICATIONS AT ALL CONCEALED SPACES AND CEILING VOIDS. TYPICALLY R-30 AT ROOFS & R-21 AT WALLS.
- 15. INSTALLATION OF ROOFING SHALL BE IN ACCORDANCE W/ MANUFACTURER
- 16. ROOFTOP EQUIPMENT AND/OR SCREENS SHALL BE PAINTED PER CITY STANDARDS OR AS OTHERWISE INDICATED IN DRAWINGS.
- 17. ALL ROOFING SHALL BE CLASS 'A' THROUGHOUT.

EDGE OF ROOF, PER CBC 1015.6

- 18. PROVIDE ROOFING TRAFFIC PADS AS INDICATED ON PLANS.
- 19. ALL ROOFTOP EQUIPMENT SHALL BE MOUNTED ON CURBS PER PLANS USING APPROVED ISOLATION MOUNTS PER PLANS & SPECIFICATIONS.
- 20. ALL ROOFS EXCEPTING THOSE ABOVE STAIR AND ELEVATOR SHAFTS SHALL BE 1 HR. RATED ROOF ASSEMBLIES. THOSE ABOVE STAIR AND ELEVATORS SHALL BE 2HR ASSEMBLIES.
- 21. PROVIDE FALL ARREST ANCHORS PER OSHA STANDARDS.
- 22. ROOF CRICKETS ARE FOR ILLUSTRATIVE PURPOSES ONLY CONTRACTOR TO VERIFY EXACT SIZE TO MEET MINIMUM REQ'D SLOPE OF 1/4":12". ROOF CRICKETS SHALL BE TAPERED FOAM CRICKETS PER SPECS INSTALLED PER MANUFACTURER RECOMMENDATIONS.
- 23. UNIT DEMISING WALLS AND CORRIDOR WALLS ARE CONTINUOUS TO UNDERSIDE OF ROOF DECK - ATTIC AREAS ARE DIVIDED INTO THEIR RESPECTIVE UNIT SIZES BELOW AND VENTILATED PER PLAN.
- 1. ADHERED SINGLE-PLY MEMBRANE ROOFING (60 MILS MIN.)
- OF OTHER MANUFACTURERS ARE SPECIFIED OR APPROVED BY THE ARCHITECT.
- 3. INSTALL MEMBRANE ROOFING SYSTEM IN ACCORDANCE WITH MANUFACTURER'S RECOMMENDATIONS AND INSTRUCTIONS, AND AS REQUIRED TO MEET THE REQUIREMENTS FOR WARRANTY AND APPLICABLE CODES.
- FULL VALUE OF THE WARRANTY.

THE SOLAR ZONE SHALL BE LOCATED ON THE ROOF OR OVERHANG OF THE BUILDING OR ON THE ROOF OR OVERHANG OF ANOTHER STRUCTURE LOCATED WITHIN 250 FEET OF THE BUILDING OR ON COVERED PARKING INSTALLED WITH THE BUILDING PROJECT, AND SHALL HAVE A TOTAL AREA NO LESS THAN 15 PERCENT OF THE TOTAL ROOF AREA OF THE BUILDING EXCLUDING ANY SKYLIGHT AREA. CBC SECTION 110.10(B)1B

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REG. NO.: C-40562

REV DESCRIPTION DATE

20 AUGUST 2024 SCHEMATIC DESIGN

4 - ARCHITECTURE

**ROOF PLAN** 



1/4" / 1'-0"
















1/4" / 1'-0"






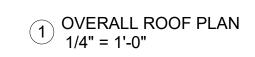








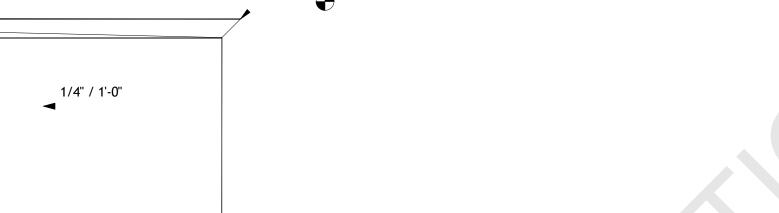





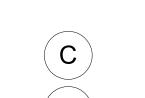


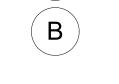


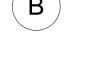


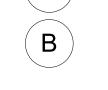


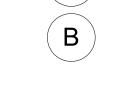


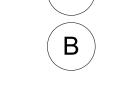


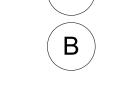

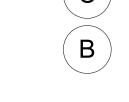


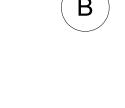

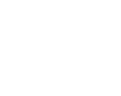


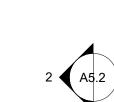



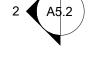



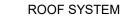

- 2. PROVIDE ROOFING SYSTEM MATERIALS BY A SINGLE MFGR., EXCEPT WHERE MATERIALS
- 4. SCHEDULE AND COORDINATE ALL MANUFACTURER REVIEWS AS REQUIRED TO OBTAIN THE

### SOLAR ZONE CALCULATION

CALCULATIONS


**ROOF AREA** 266 SF REQUIRED


SOLAR ZONE 1 266 SF

TOTAL SOLAR ZONE 266 SF PROVIDED (OK)





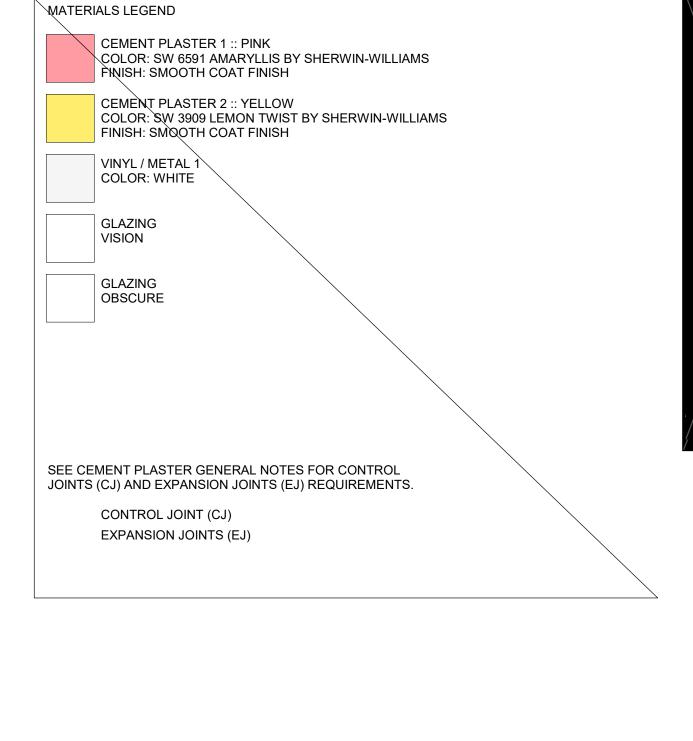

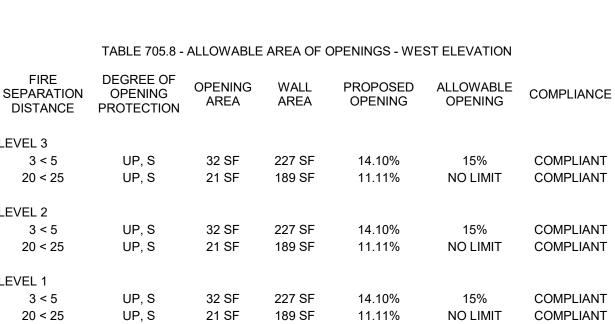

REV DESCRIPTION DATE

CA 92102

FIRE SEPARATION DISTANCE	DEGREE OF OPENING PROTECTION	OPENING AREA	WALL AREA	PROPOSED OPENING	ALLOWABLE OPENING	COMPLIANCE
LEVEL 3						
3 < 5	UP, S	32 SF	227 SF	14.10%	15%	COMPLIANT
20 < 25	UP, S	21 SF	189 SF	11.11%	NO LIMIT	COMPLIANT
LEVEL 2						
3 < 5	UP, S	32 SF	227 SF	14.10%	15%	COMPLIANT
20 < 25	UP, S	21 SF	189 SF	11.11%	NO LIMIT	COMPLIANT
20 . 20	01,0	2101	100 01	11.1170	NO LIMIT	COMI EN MAI
LEVEL 1						
3 < 5	UP, S	32 SF	227 SF	14.10%	15%	COMPLIANT
20 < 25	UP, S	21 SF	189 SF	11.11%	NO LIMIT	COMPLIANT

TABLE 705.8 - ALLOWABLE AREA OF OPENINGS - SOUTH ELEVATION

FIRE DEGREE OF OPENING WALL PROPOSED ALLOWABLE COMPLIANCE DISTANCE PROTECTION AREA AREA OPENING OPENING

27 SF 188 SF 14.36%

27 SF 188 SF 14.36%

21 SF

141 SF 14.89%

21 SF 141 SF 14.89%

3 < 5 20 < 25

3 < 5

20 < 25

UP, S

LEVEL 2

LEVEL 1 3 < 5

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20 AUGUST 2024
SCHEMATIC DESIGN
SHEET DISCIPLINE 4 - ARCHITECTURE
SHEET NAME EXTERIOR ELEVATIO


15% COMPLIANT

15% COMPLIANT


NO LIMIT COMPLIANT

NO LIMIT COMPLIANT



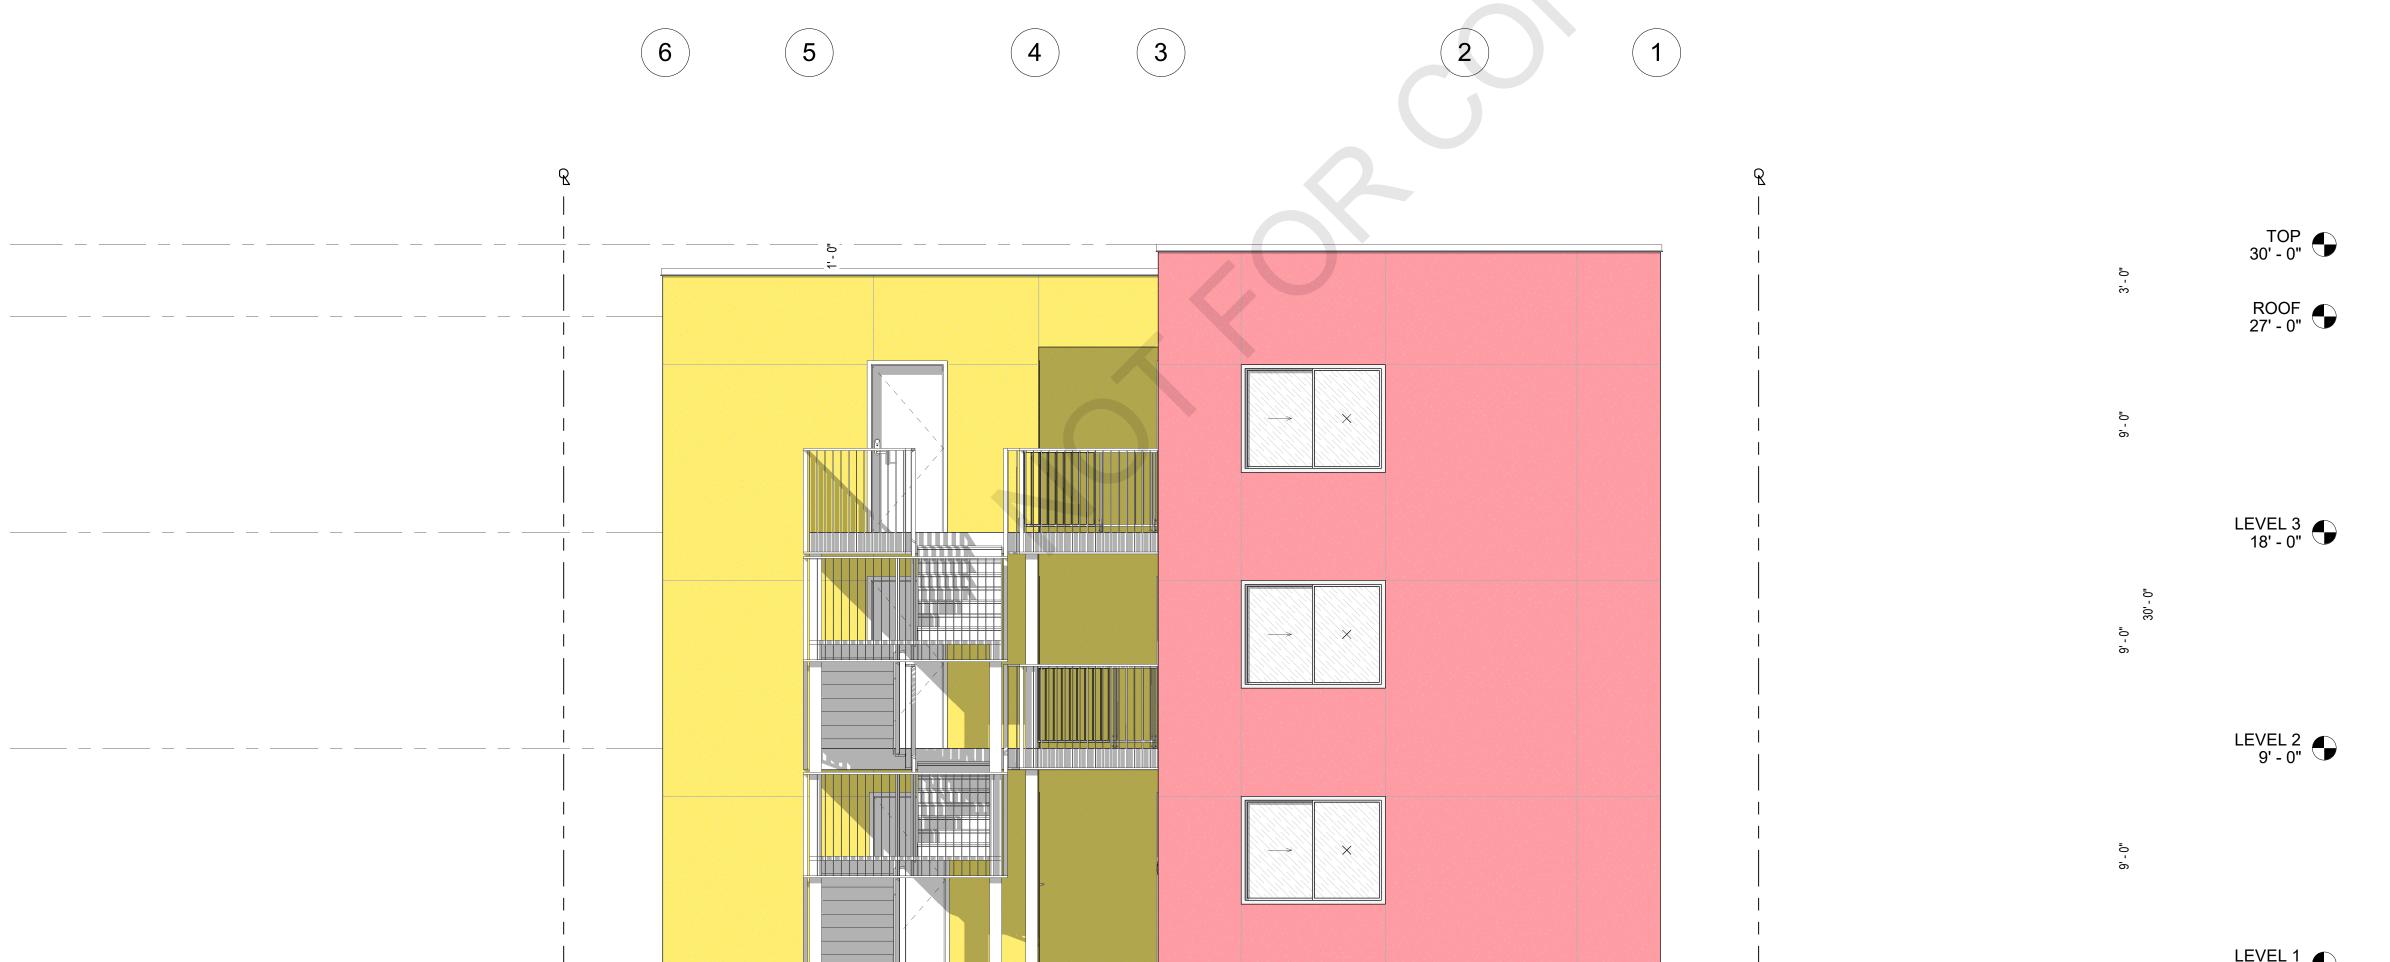

WEST ELEVATION
1/4" = 1'-0"

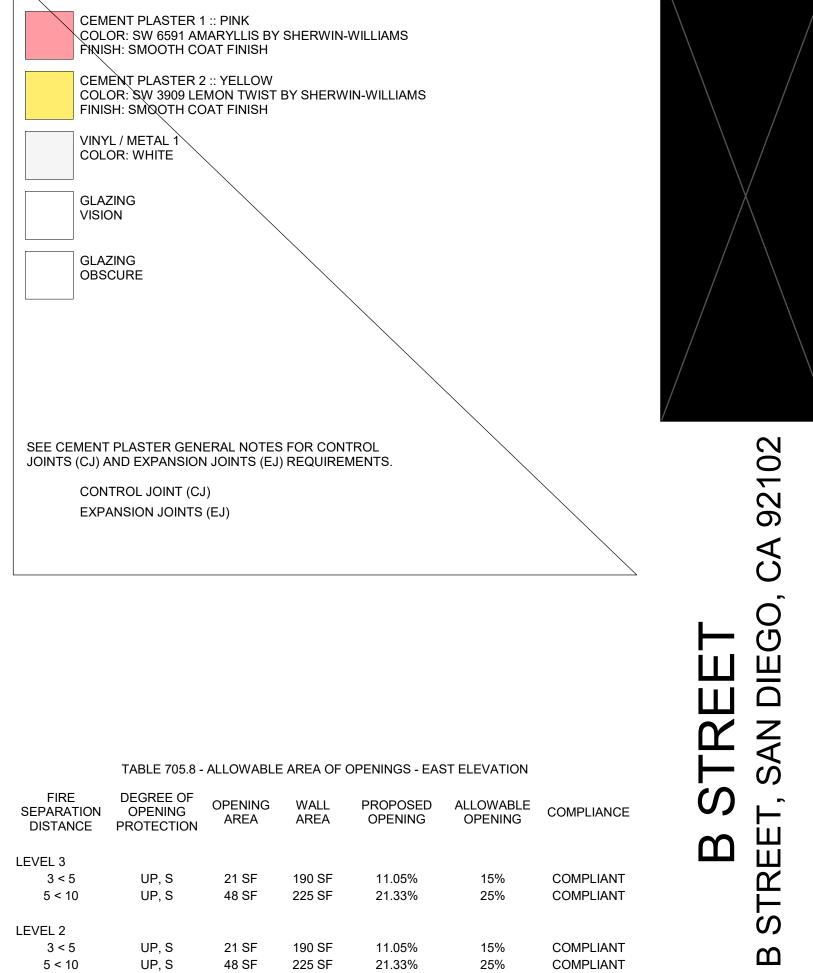

MATERIALS LEGEND

LEVEL 1

3 < 5


5 < 10

UP, S

21 SF 190 SF

48 SF 225 SF 21.33%

11.05%

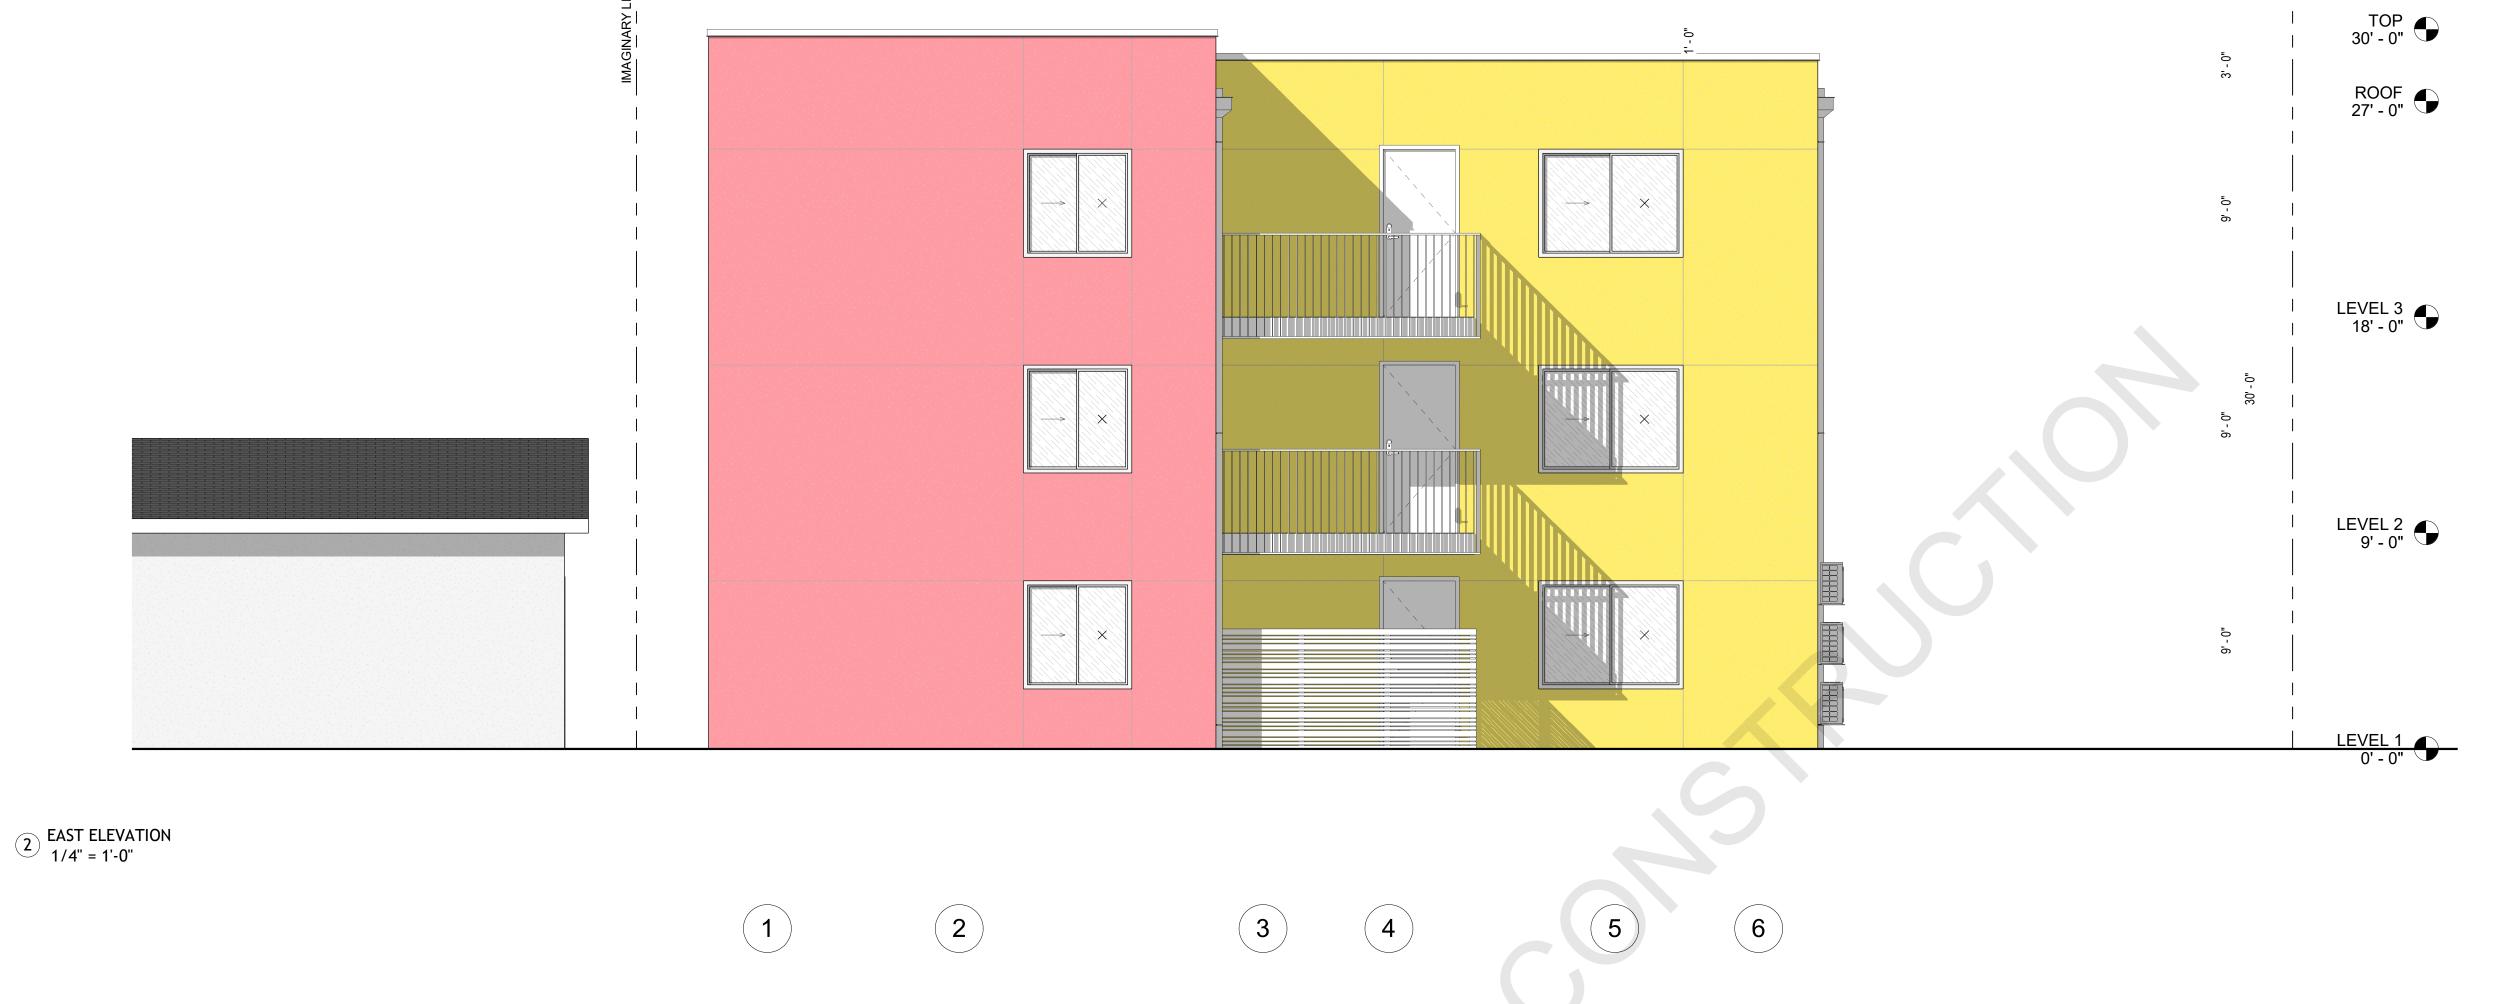

A

1 2	3 4	5 6	
R 		0." B	TOP 30' - 0"
			ROOF 27' - 0"
			້ອ LEVEL 3 18' - 0"
			9 0"
			LEVEL 2 9' - 0"
			້ວ ອີ LEVEL 1 👝

REV DESCRIPTION DATE

COMPLIANT

COMPLIANT

15%

25%

INTERIM REVIEW ONLY
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ARCHITECT: THOMAS SEARS

REG. NO.: C-40562

20 AUGUST 2024

ISSUE
SCHEMATIC DESIGN

SHEET DISCIPLINE
4 - ARCHITECTURE

SHEET NAME
EXTERIOR ELEVATIONS

SHEET NUMBER

TABLE 705.8 - ALLOWABLE AREA OF OPENINGS - NORTH ELEVATION

FIRE DEGREE OF OPENING WALL PROPOSED ALLOWABLE COMPLIANCE DISTANCE PROTECTION AREA AREA OPENING OPENING

A5.2